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LOCATION MAP
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Symbol	Description	Date	Approved
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DEPARTMENT OF THE ARMY CORPS OF ENGINEERS SACRAMENTO, CALIFORNIA	Designed by:	Date:	Rev.
	Dwn by:	Spec No.:	Design file no:
	Reviewed by:	Drawing Code:	
	Submitted by:	File name:	
	CHEF, CIV ENGR DES SEC A	Plot date:	\$\$\$\$\$\$
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SACRAMENTO DISTRICT HEADQUARTERS 1370 J STREET SACRAMENTO, CA 95814-2922			

SUTTER & BUTTE COUNTY CALIFORNIA
SUTTER BASIN PILOT FEASIBILITY STUDY
DRAFT REPORT
ALTERNATIVE SB-7 AND SB-8
COVER SHEET

Sheet
reference
number:


G-1

NOT FOR CONSTRUCTION


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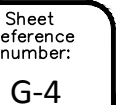


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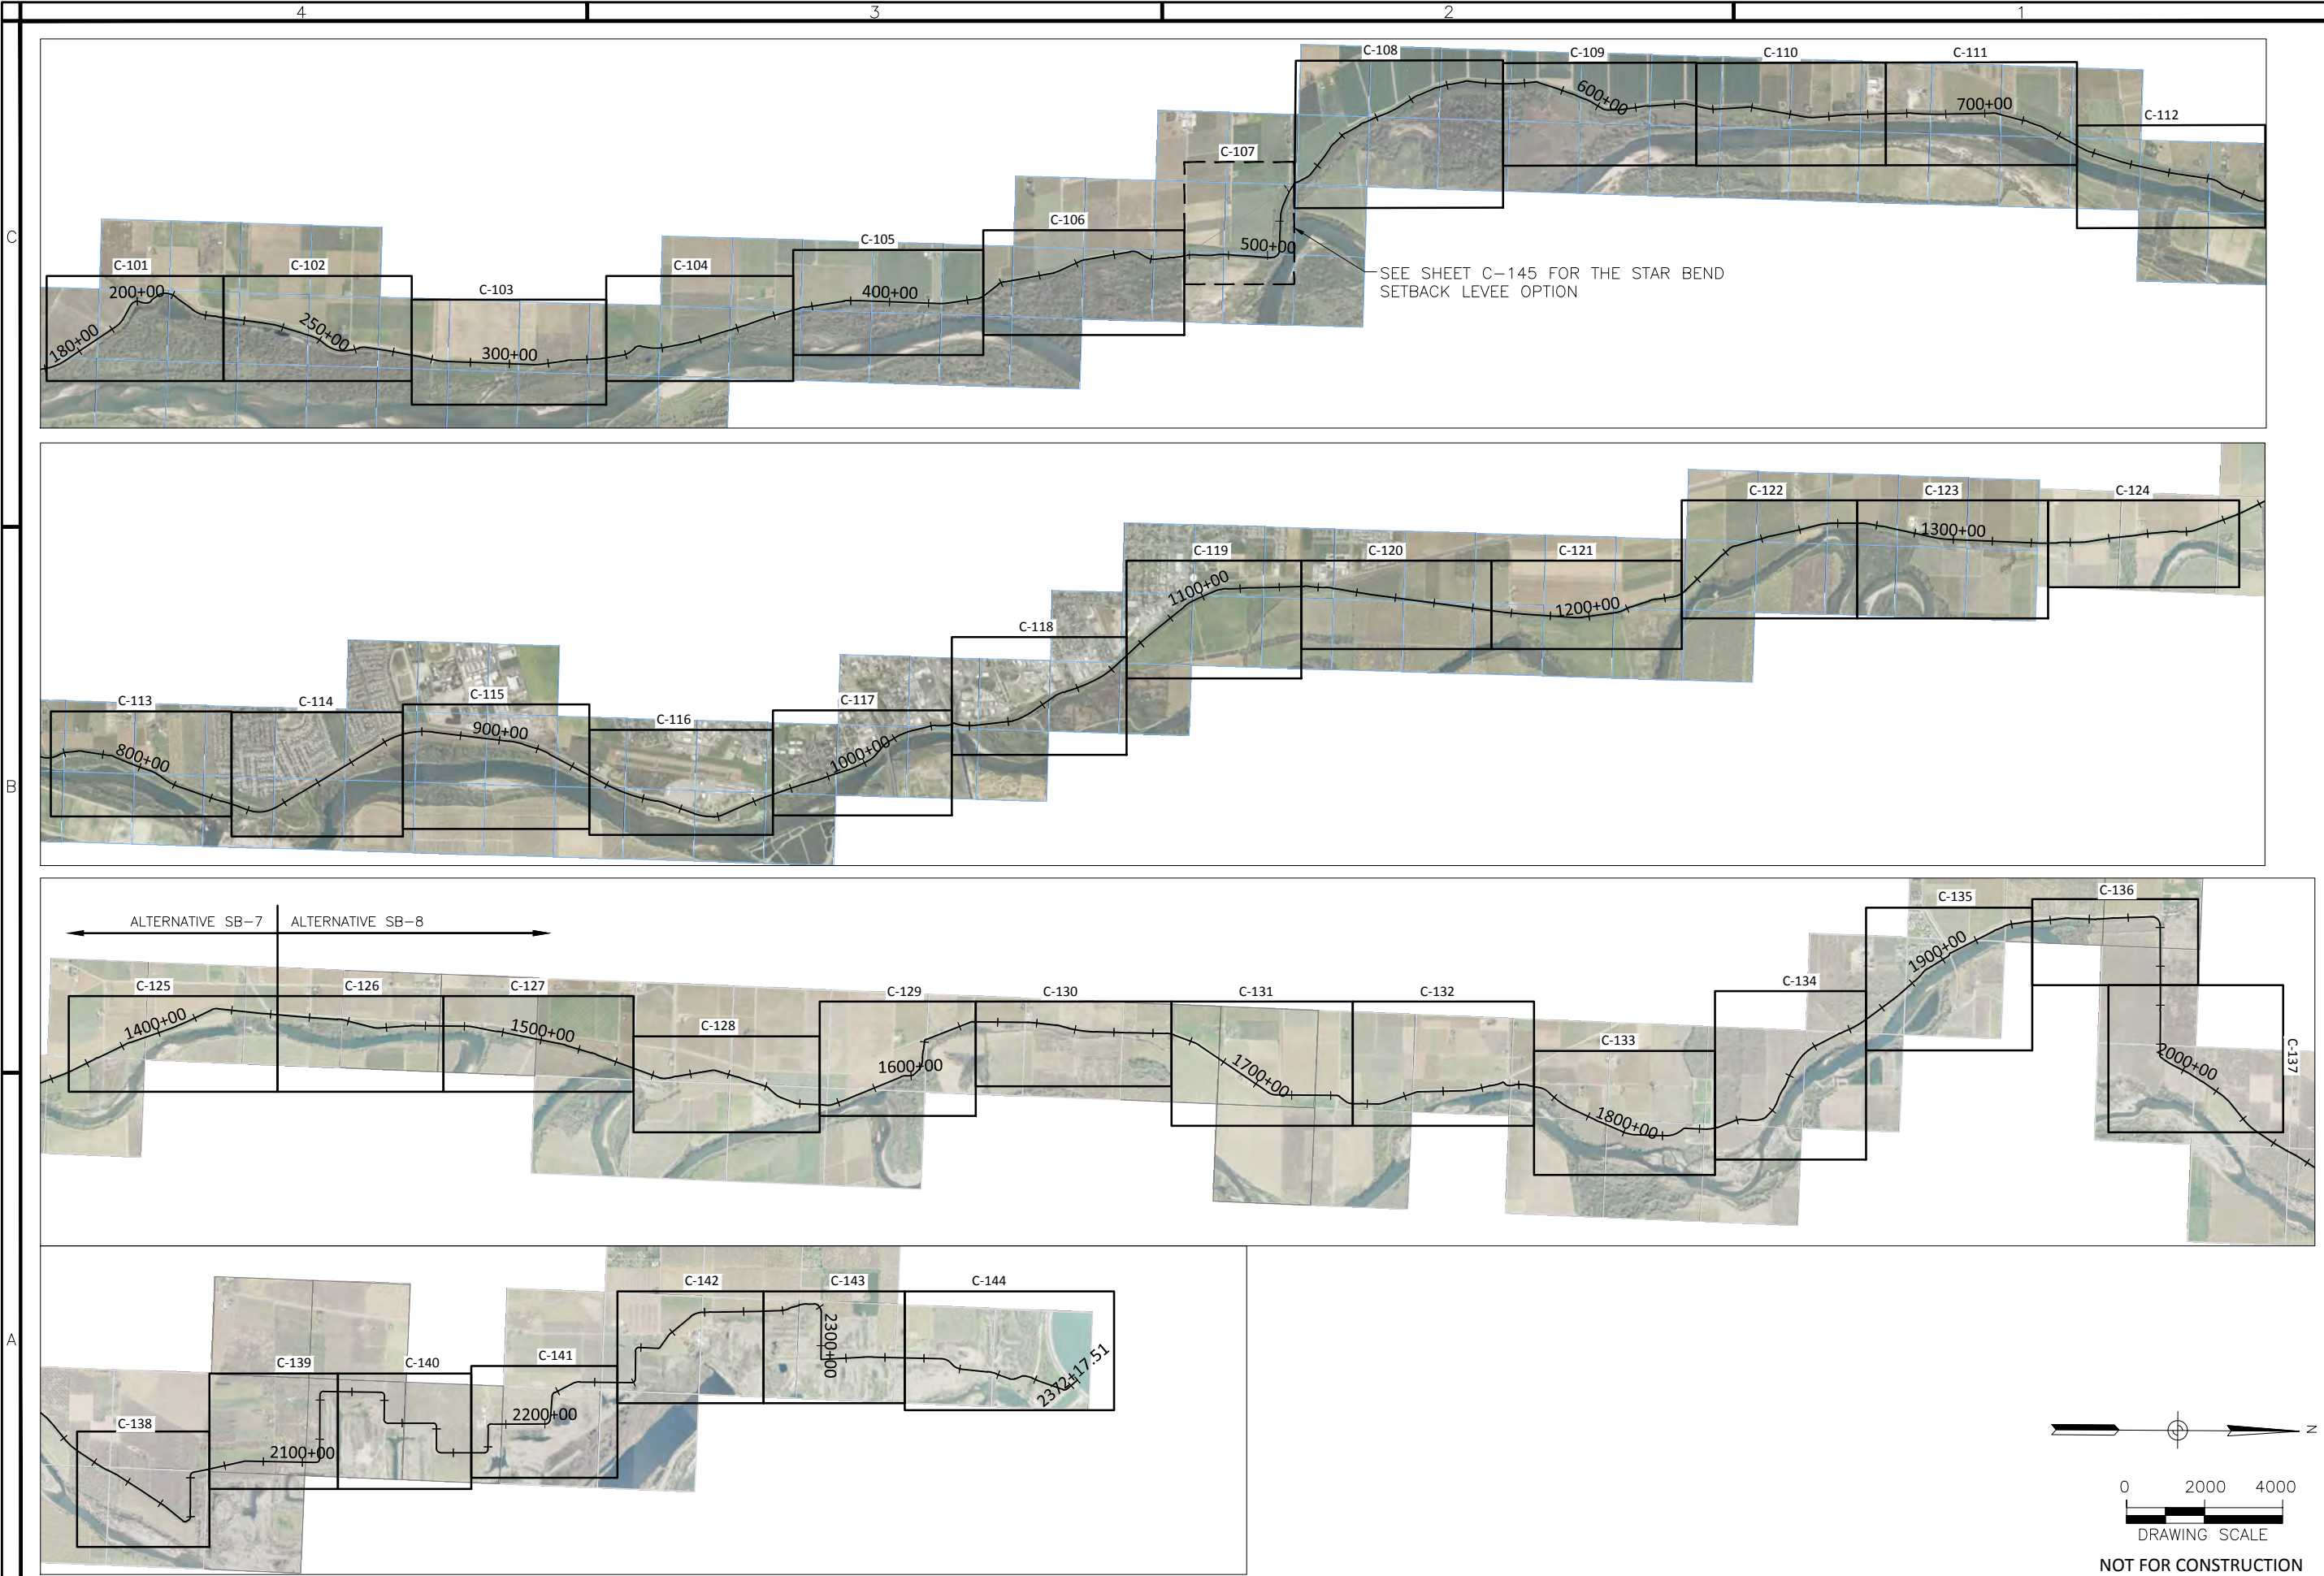


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Sheet
reference
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G-5

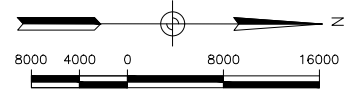

US Army Corps of Engineers
Sacramento District
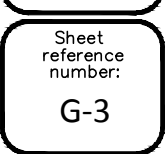
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DATE 100	APPROVAL	DESCRIPTION 100	100		

DESIGNED BY: _____

DRAWN BY: _____

REVIEWED BY: _____

SUBMITTED BY: _____

CHECKED BY: _____

DEPARTMENT OF THE ARMY
CORPS OF ENGINEERS
SACRAMENTO, CALIFORNIA



SACRAMENTO DISTRICT
HOUSE DESIGN
1325 J STREET
SACRAMENTO, CA 95814-2922

SUTTER & BUTTE COUNTY CALIFORNIA
SUTTER BASIN PILOT FEASIBILITY STUDY
DRAFT REPORT
ALTERNATIVE SB-7 AND SB-8
OVERALL SITE PLAN AND KEY MAP

Sheet reference number:
G-8



HORIZONTAL DATUM
THE HORIZONTAL DATUM OF THIS SURVEY IS THE NORTH AMERICAN DATUM OF 1983 (NAD83) BEING THE CALIFORNIA COORDINATE SYSTEM OF 1983 ZONE 2 (GRID SURFACE).

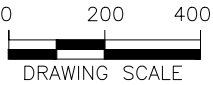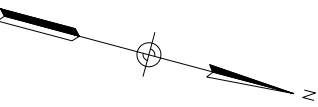

DRAWING SCALE
NOT FOR CONSTRUCTION

US Army Corps of Engineers
Sacramento District

DATE APPROVED	DESCRIPTION	Rev.	Date
DATE APPROVED	DESCRIPTION 8	Rev.	Date
DATE APPROVED	DESCRIPTION 7	Rev.	Date
DATE APPROVED	DESCRIPTION 6	Rev.	Date
DATE APPROVED	DESCRIPTION 5	Rev.	Date
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Designed by: _____

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Reviewed by: _____

Submitted by: _____

File name: \$\$\$\$Mat-\$\$\$

Plot date: _____

Plot scale: _____



DEPARTMENT OF THE ARMY
CORPS OF ENGINEERS
SACRAMENTO, CALIFORNIA

SACRAMENTO DISTRICT
HOUSE DESIGN
1325 J STREET
SACRAMENTO, CA 95814-2922

SUTTER & BUTTE COUNTY CALIFORNIA
SUTTER BASIN PILOT FEASIBILITY STUDY
DRAFT REPORT
ALTERNATIVE SB-7 AND SB-8
PLAN VIEW
STA 325+00 TO 375+00

Sheet reference number:
C-104

THE HORIZONTAL DATUM OF THIS SURVEY IS THE NORTH AMERICAN DATUM OF 1983 (NAD83) BEING THE CALIFORNIA COORDINATE SYSTEM OF 1983 ZONE 2 (GRID SURFACE).

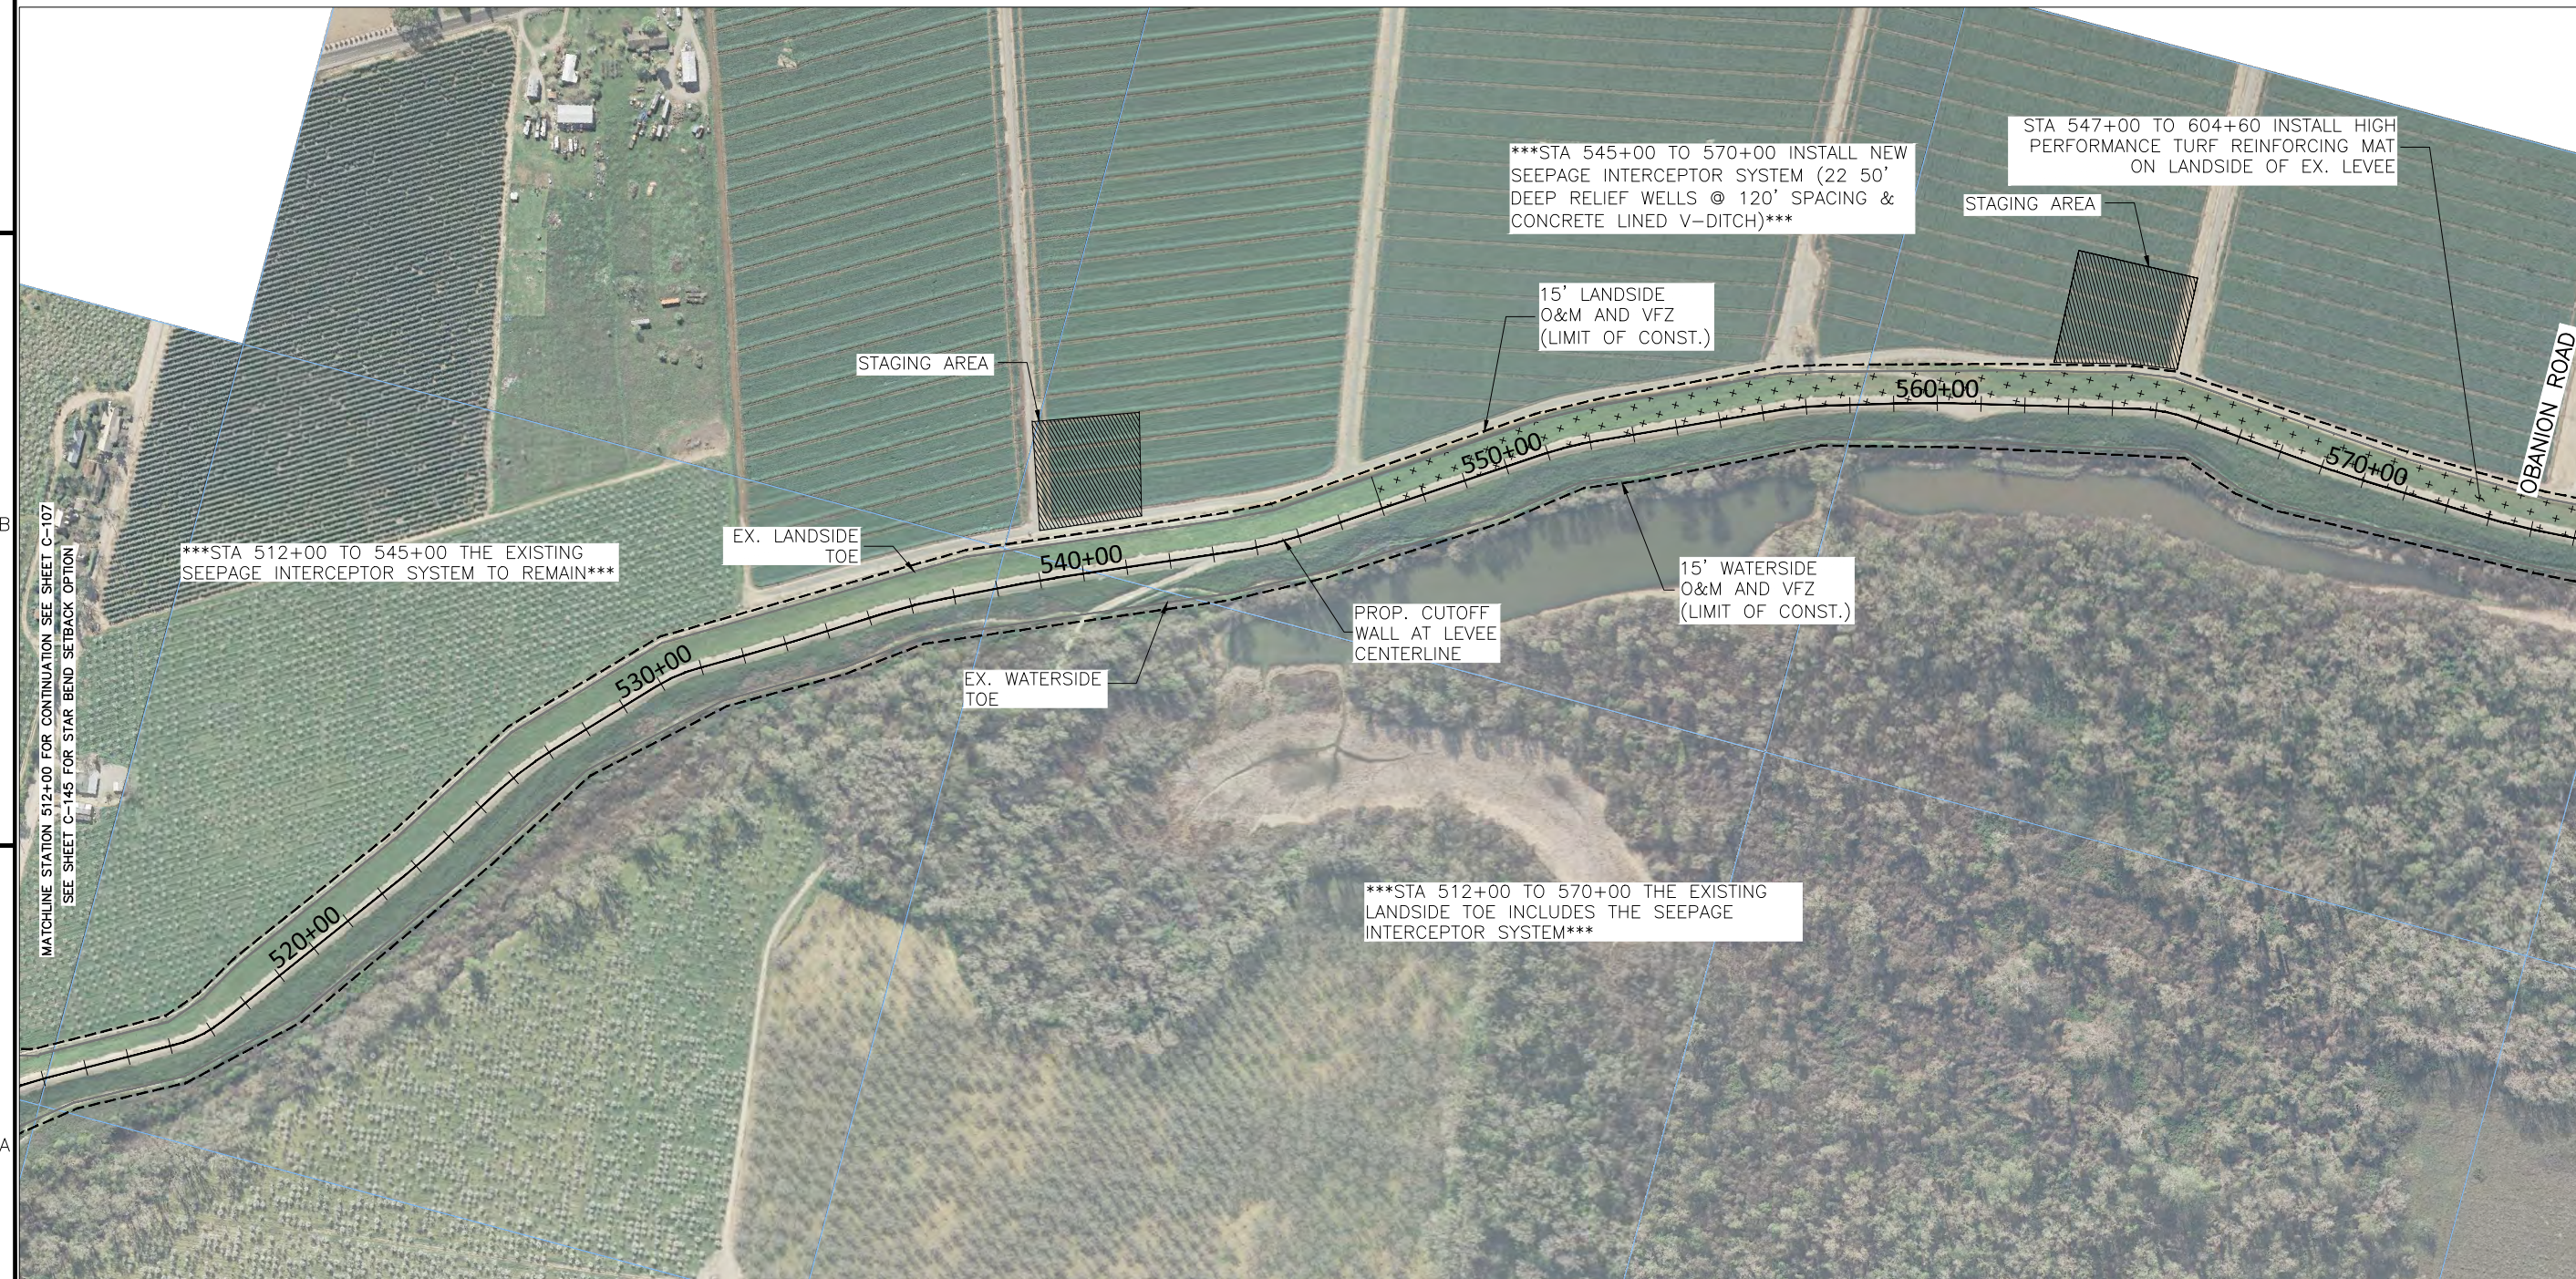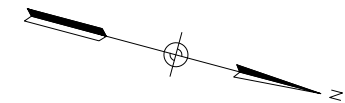

A horizontal scale bar with tick marks at 0, 200, and 400. The bar is divided into segments: a white segment from 0 to 100, a black segment from 100 to 200, a white segment from 200 to 300, a black segment from 300 to 400, and a white segment from 400 to 500. The text "DRAWING SCALE" is centered below the bar.

NOT FOR CONSTRUCTION

DEPARTMENT OF THE ARMY					
CORPS OF ENGINEERS					
SACRAMENTO, CALIFORNIA					
SACRAMENTO DISTRICT					
IN HOUSE DESIGN					
1325 J STREET					
SACRAMENTO, CA 95814-2922					
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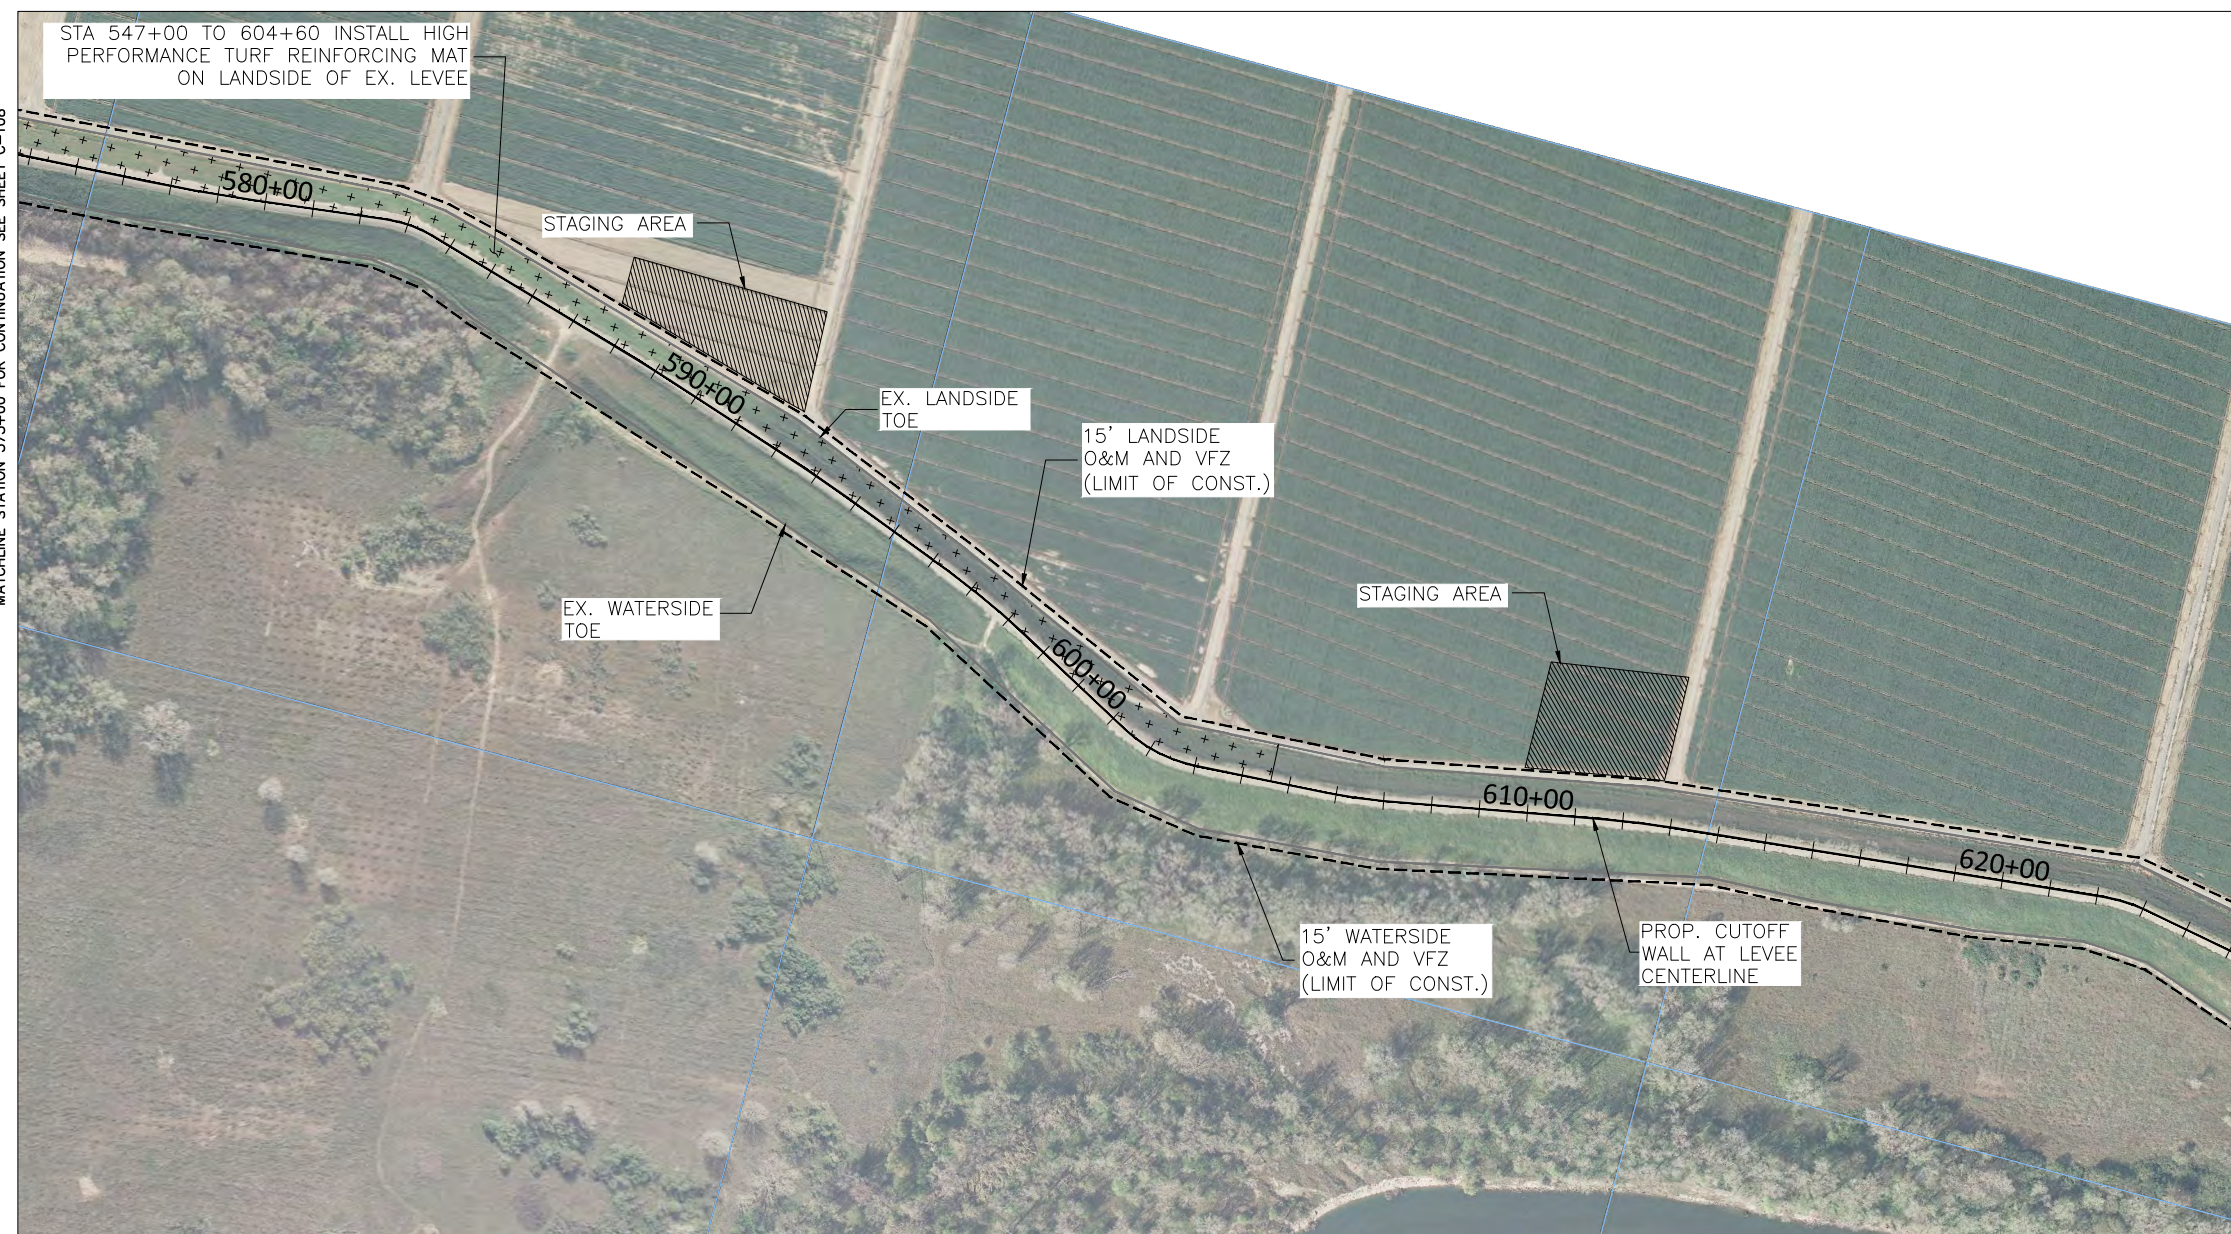
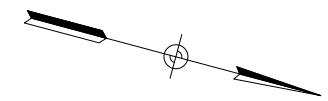
SUTTER & BUTTE COUNTY CALIFORNIA
SUTTER BASIN PILOT FEASIBILITY STUDY
DRAFT REPORT
ALTERNATIVE SB-7 AND SB-8
PLAN VIEW
STA 512+00 TO 575+00

Sheet
reference
number:
C-108

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THE HORIZONTAL DATUM OF THIS SURVEY IS THE NORTH AMERICAN DATUM OF 1983 (NAD83) BEING THE CALIFORNIA COORDINATE SYSTEM OF 1983 ZONE 2 (GRID SURFACE).



A horizontal scale bar with tick marks at 0, 200, and 400. The bar is divided into segments: a white segment from 0 to 100, a black segment from 100 to 200, a white segment from 200 to 300, and a black segment from 300 to 400. The text "DRAWING SCALE" is centered below the bar.

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DEPARTMENT OF THE ARMY CORPS OF ENGINEERS SACRAMENTO, CALIFORNIA	Designed by:	Date:	Rev.
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	Drawn by:	Spec No.:	Design file no.:
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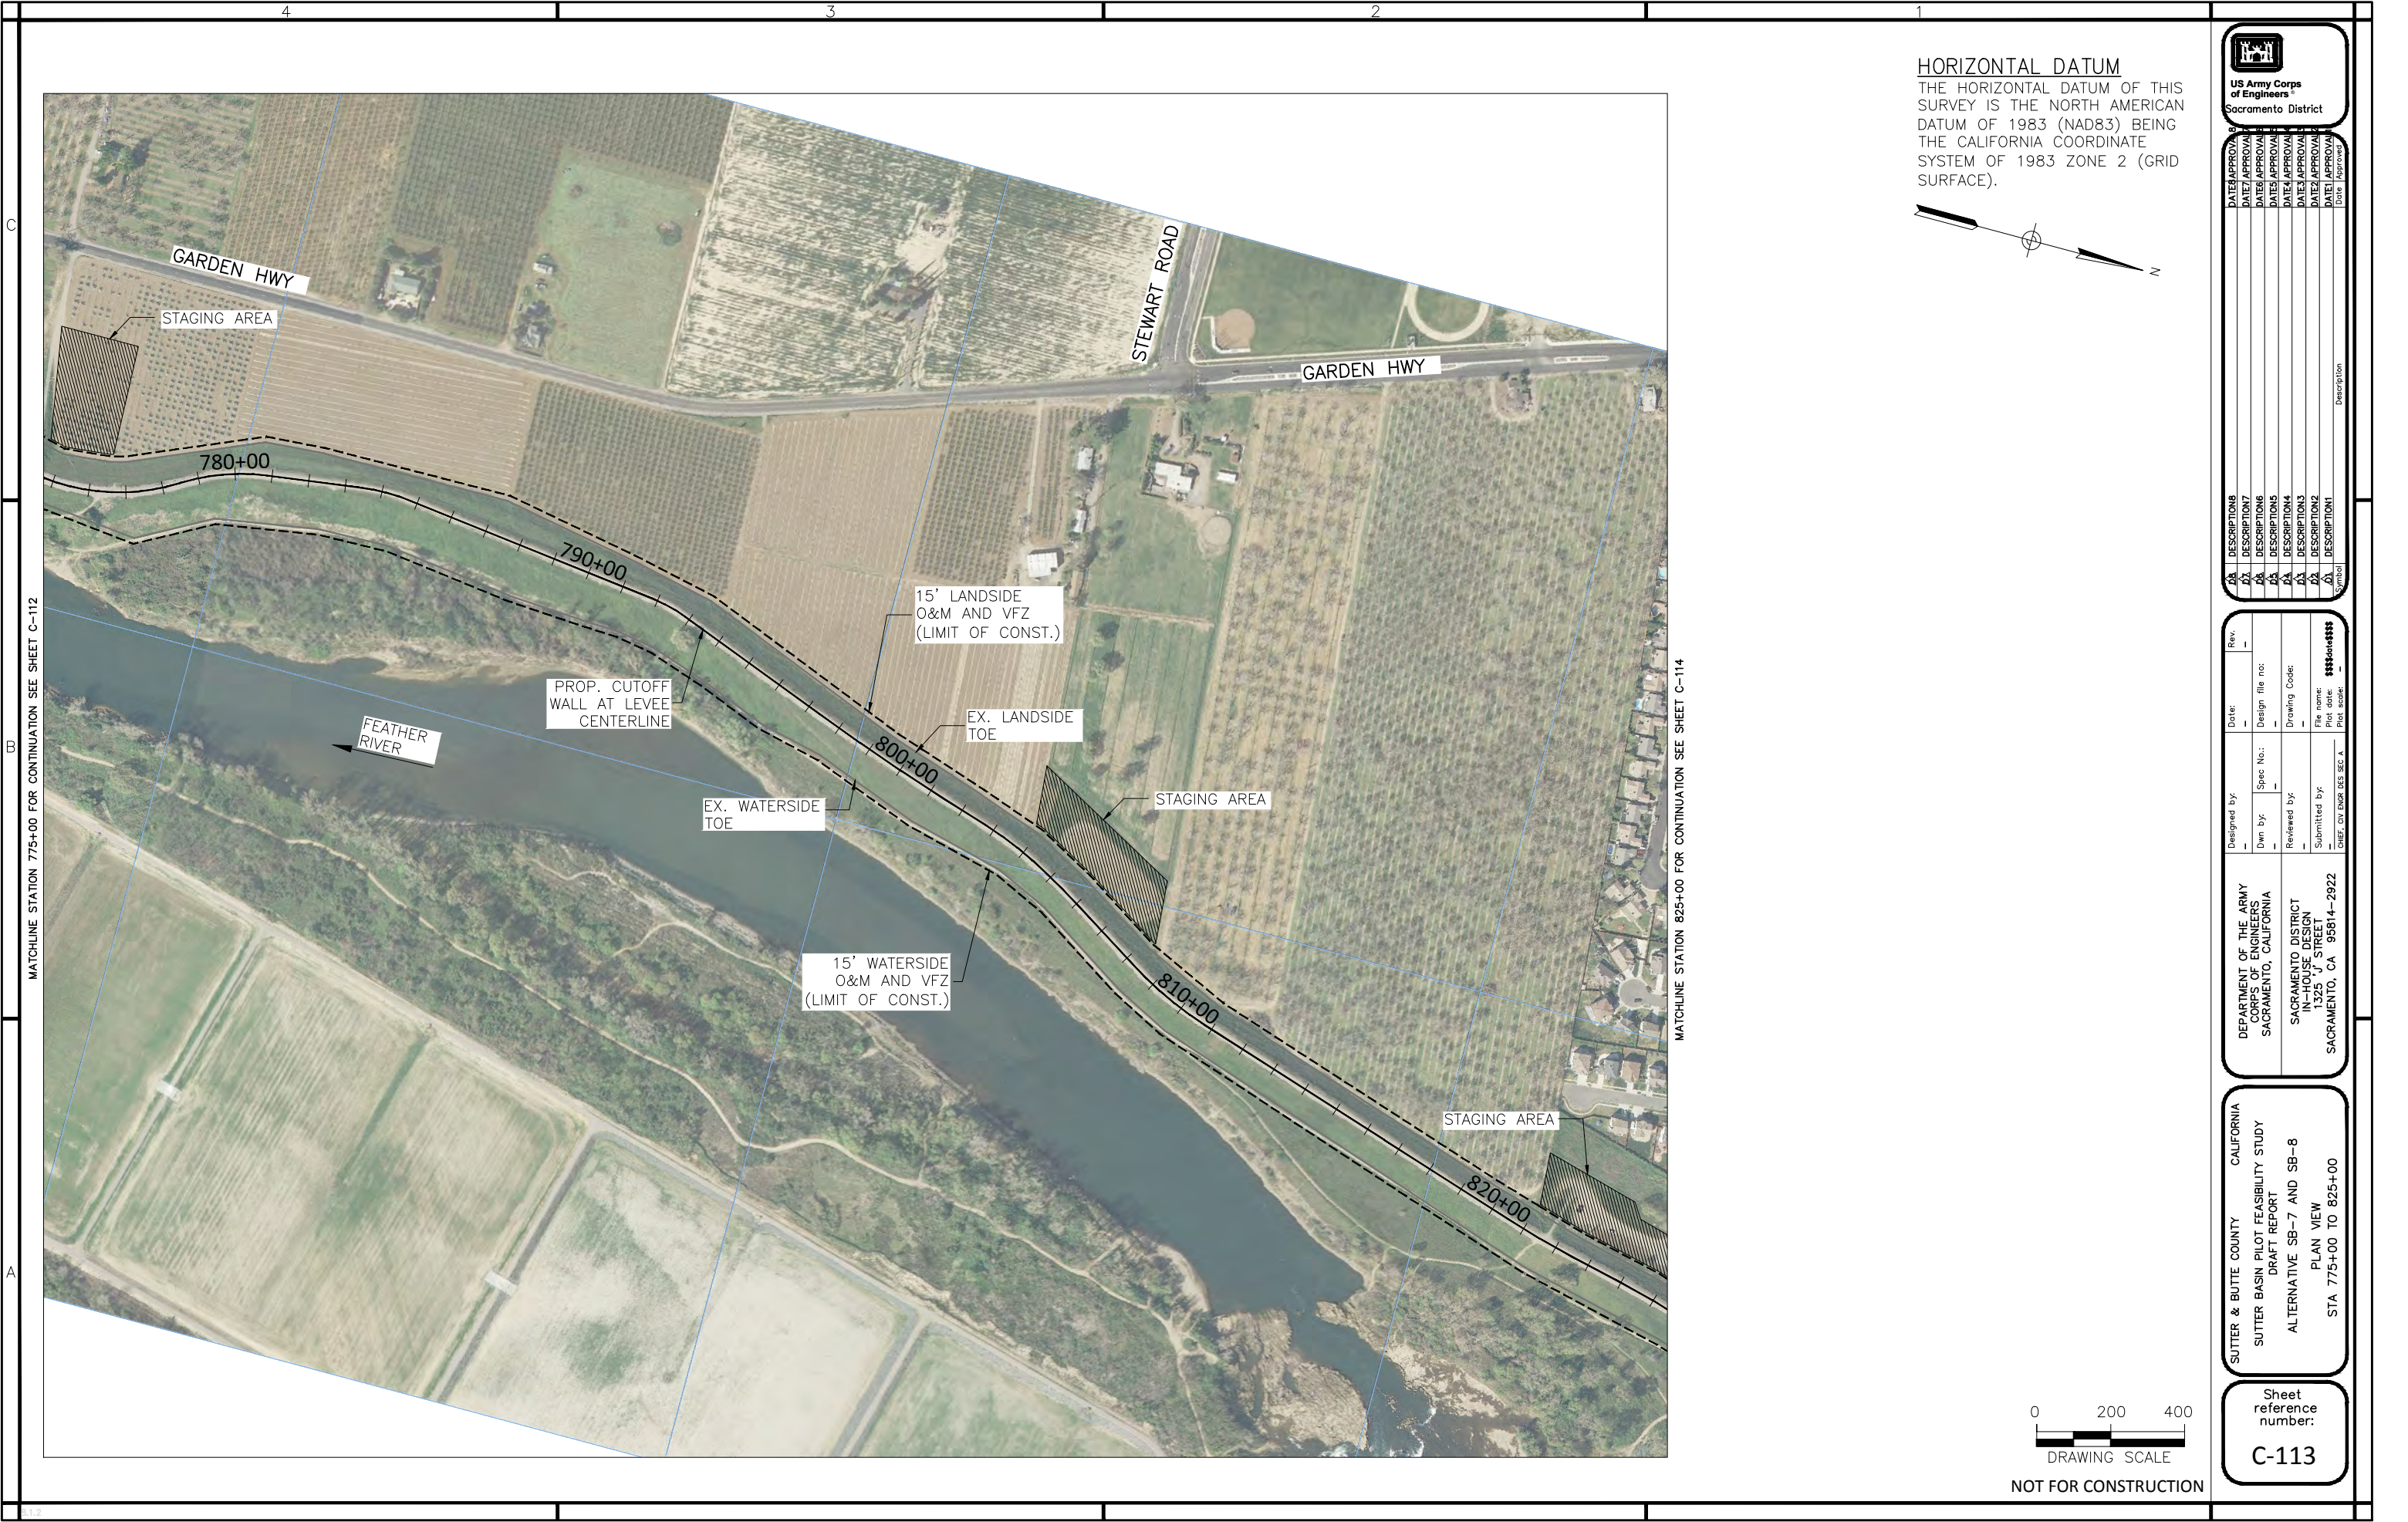
SUTTER & BUTTE COUNTY CALIFORNIA
SUTTER BASIN PILOT FEASIBILITY STUDY
DRAFT REPORT
ALTERNATIVE SB-7 AND SB-8
PLAN VIEW
STA 575+00 TO 625+00

Sheet
reference
number:
C-109



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Q7	DESCRIPTION1	DATE1 APPROVAL



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Sacramento District



HORIZONTAL DATUM
THE HORIZONTAL DATUM OF THIS SURVEY IS THE NORTH AMERICAN DATUM OF 1983 (NAD83) BEING THE CALIFORNIA COORDINATE SYSTEM OF 1983 ZONE 2 (GRID SURFACE).

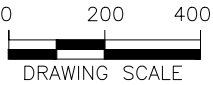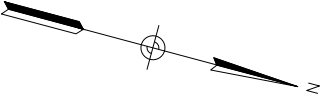

DRAWING SCALE
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US Army Corps of Engineers
Sacramento District

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DEPARTMENT OF THE ARMY
CORPS OF ENGINEERS
SACRAMENTO, CALIFORNIA

SACRAMENTO DISTRICT
HOUSE DESIGN
1325 J STREET
SACRAMENTO, CA 95814-2922

SUTTER & BUTTE COUNTY CALIFORNIA
SUTTER BASIN PILOT FEASIBILITY STUDY
DRAFT REPORT
ALTERNATIVE SB-7 AND SB-8
PLAN VIEW
STA 775+00 TO 825+00

Sheet reference number:
C-113



Sheet
reference
number:

C-115

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HORIZONTAL DATUM
THE HORIZONTAL DATUM OF THIS SURVEY IS THE NORTH AMERICAN DATUM OF 1983 (NAD83) BEING THE CALIFORNIA COORDINATE SYSTEM OF 1983 ZONE 2 (GRID SURFACE).

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DEPARTMENT OF THE ARMY
CORPS OF ENGINEERS
SACRAMENTO, CALIFORNIA

SACRAMENTO DISTRICT
HOUSE DESIGN
1325 J STREET
SACRAMENTO, CA 95814-2922

SUTTER & BUTTE COUNTY CALIFORNIA

SUTTER BASIN PILOT FEASIBILITY STUDY
DRAFT REPORT

ALTERNATIVE SB-7 AND SB-8
PLAN VIEW

STA 1375+00 TO 1433+83

Sheet reference number:
C-125

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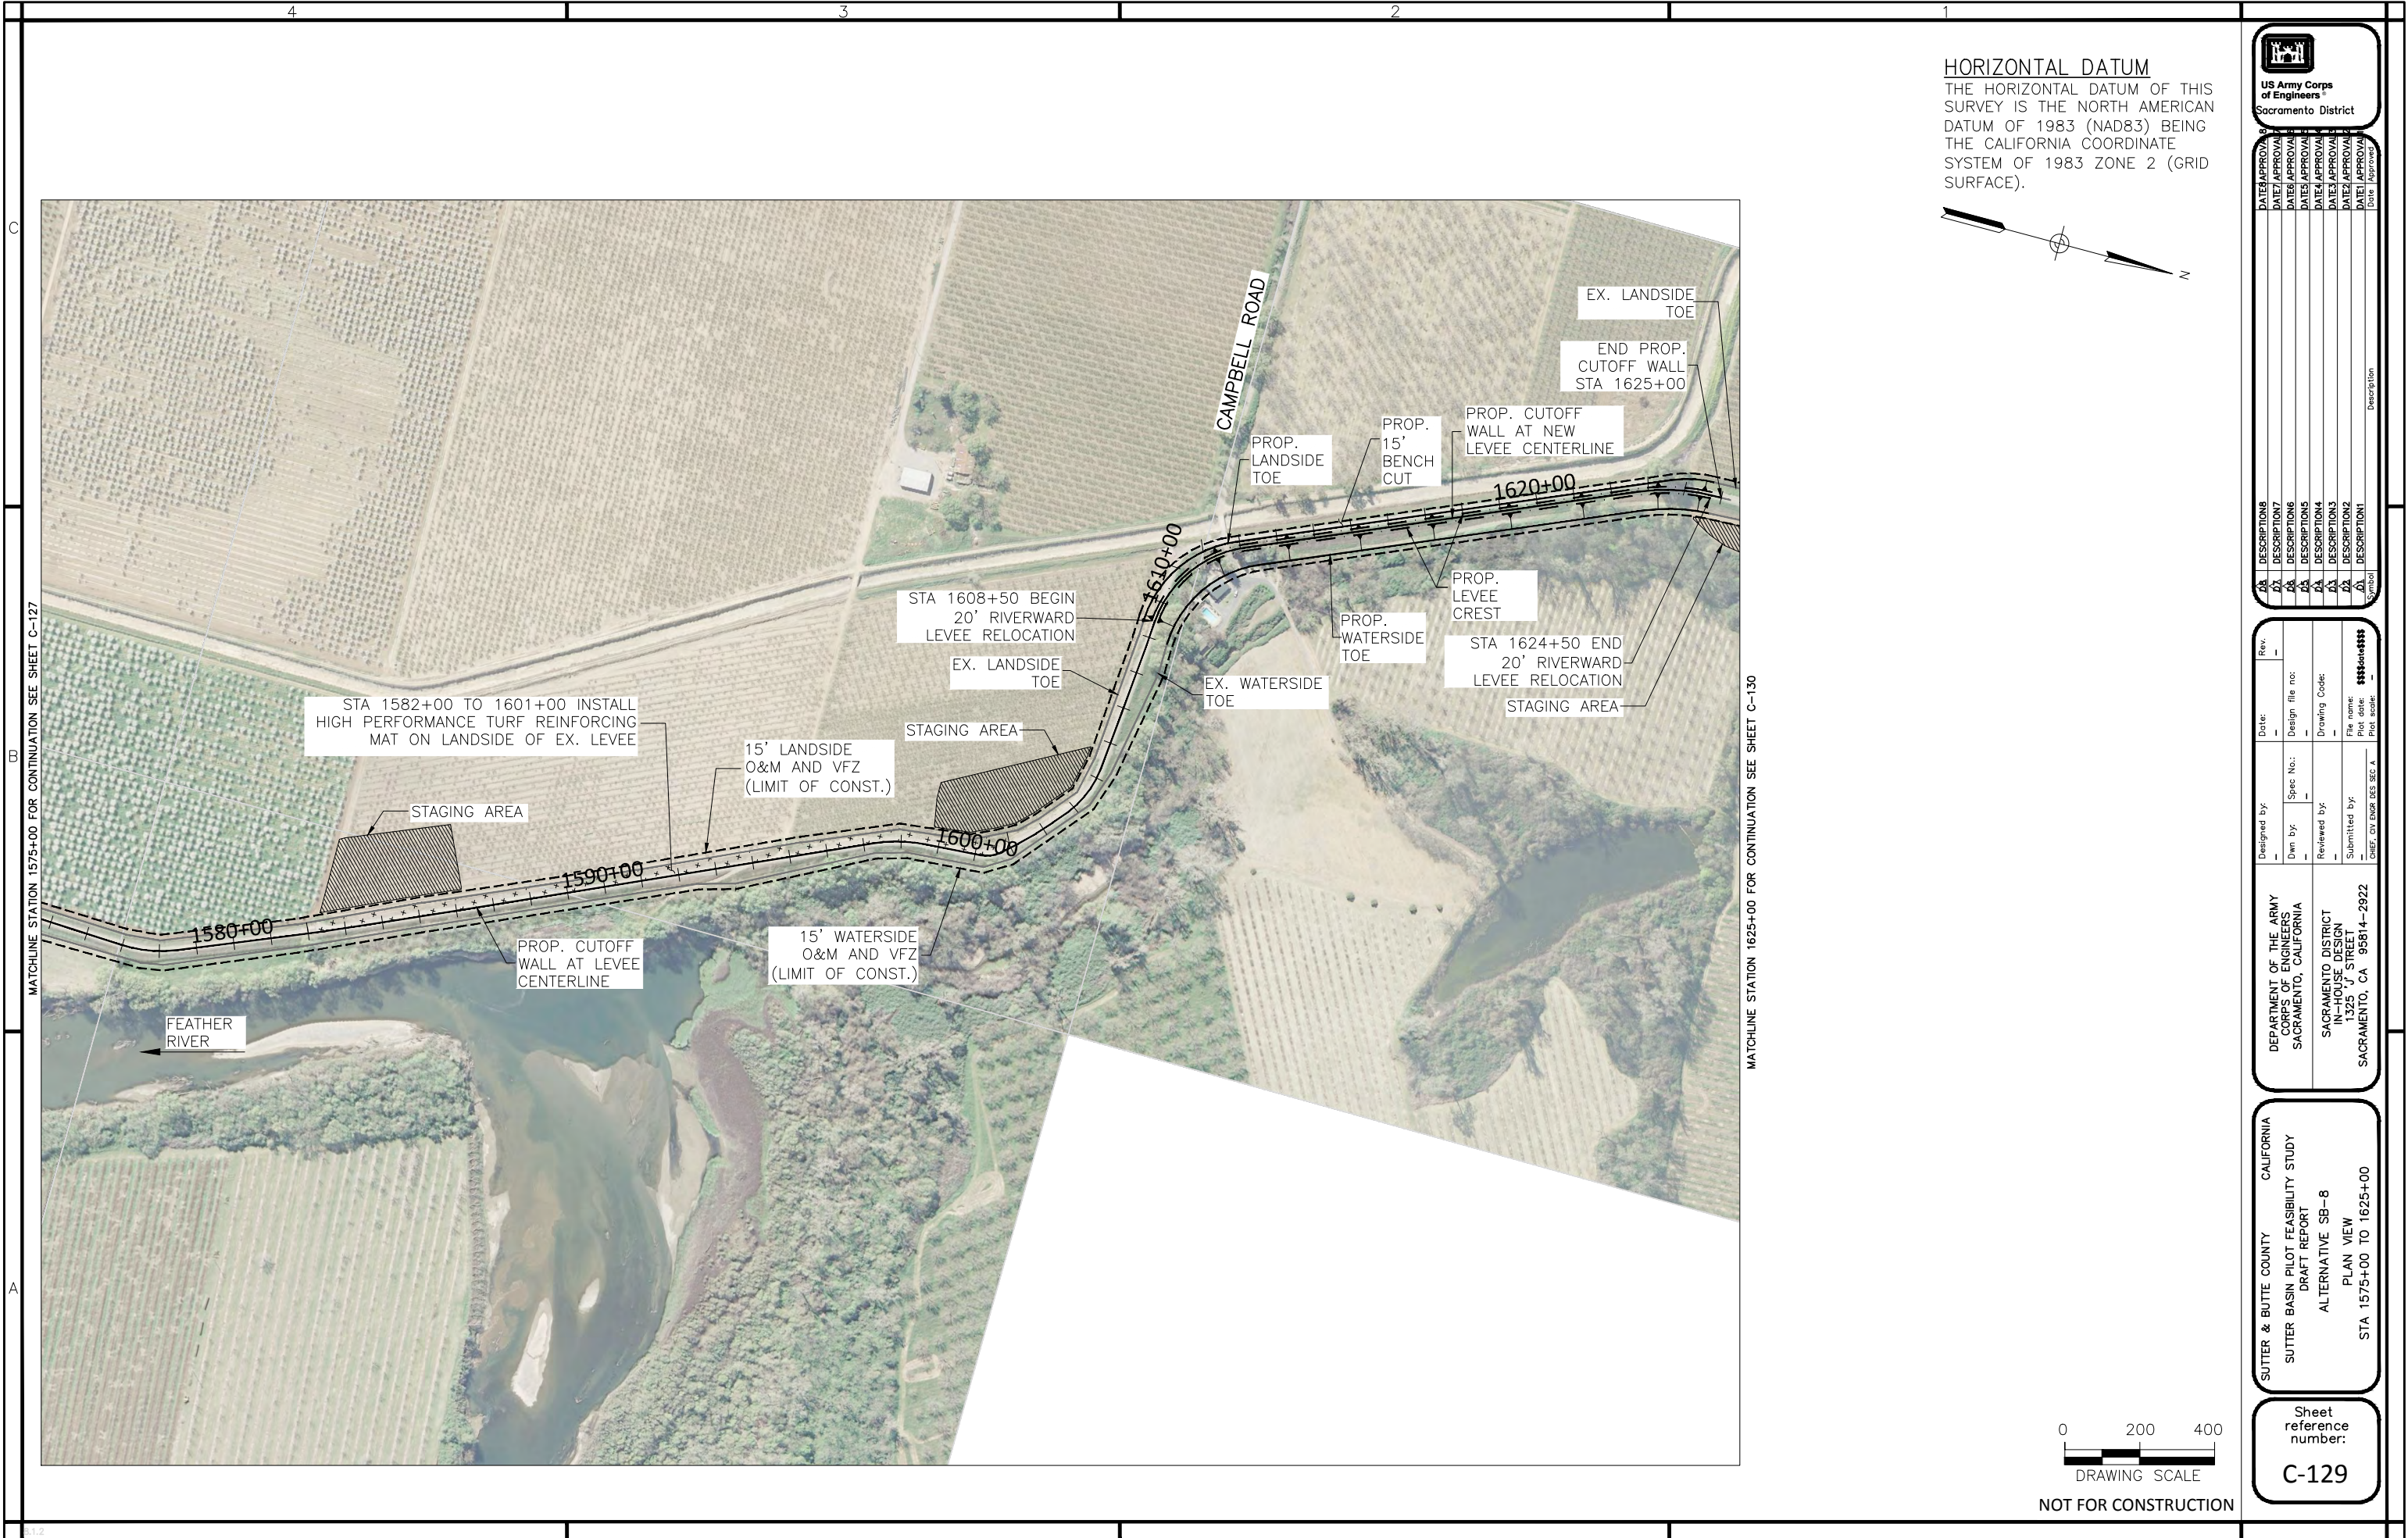
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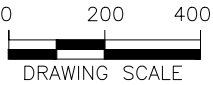
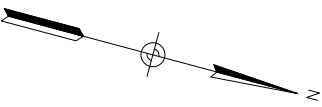


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C-127



HORIZONTAL DATUM
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US Army Corps of Engineers
Sacramento District


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Rev.	Rev.	Rev.	Rev.	Rev.	Rev.	Rev.	Rev.	Rev.	Rev.
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Designed by:	Spec No.:	Design file no.:	Drawing Code:	File name:	Plot date:	Plot scale:			
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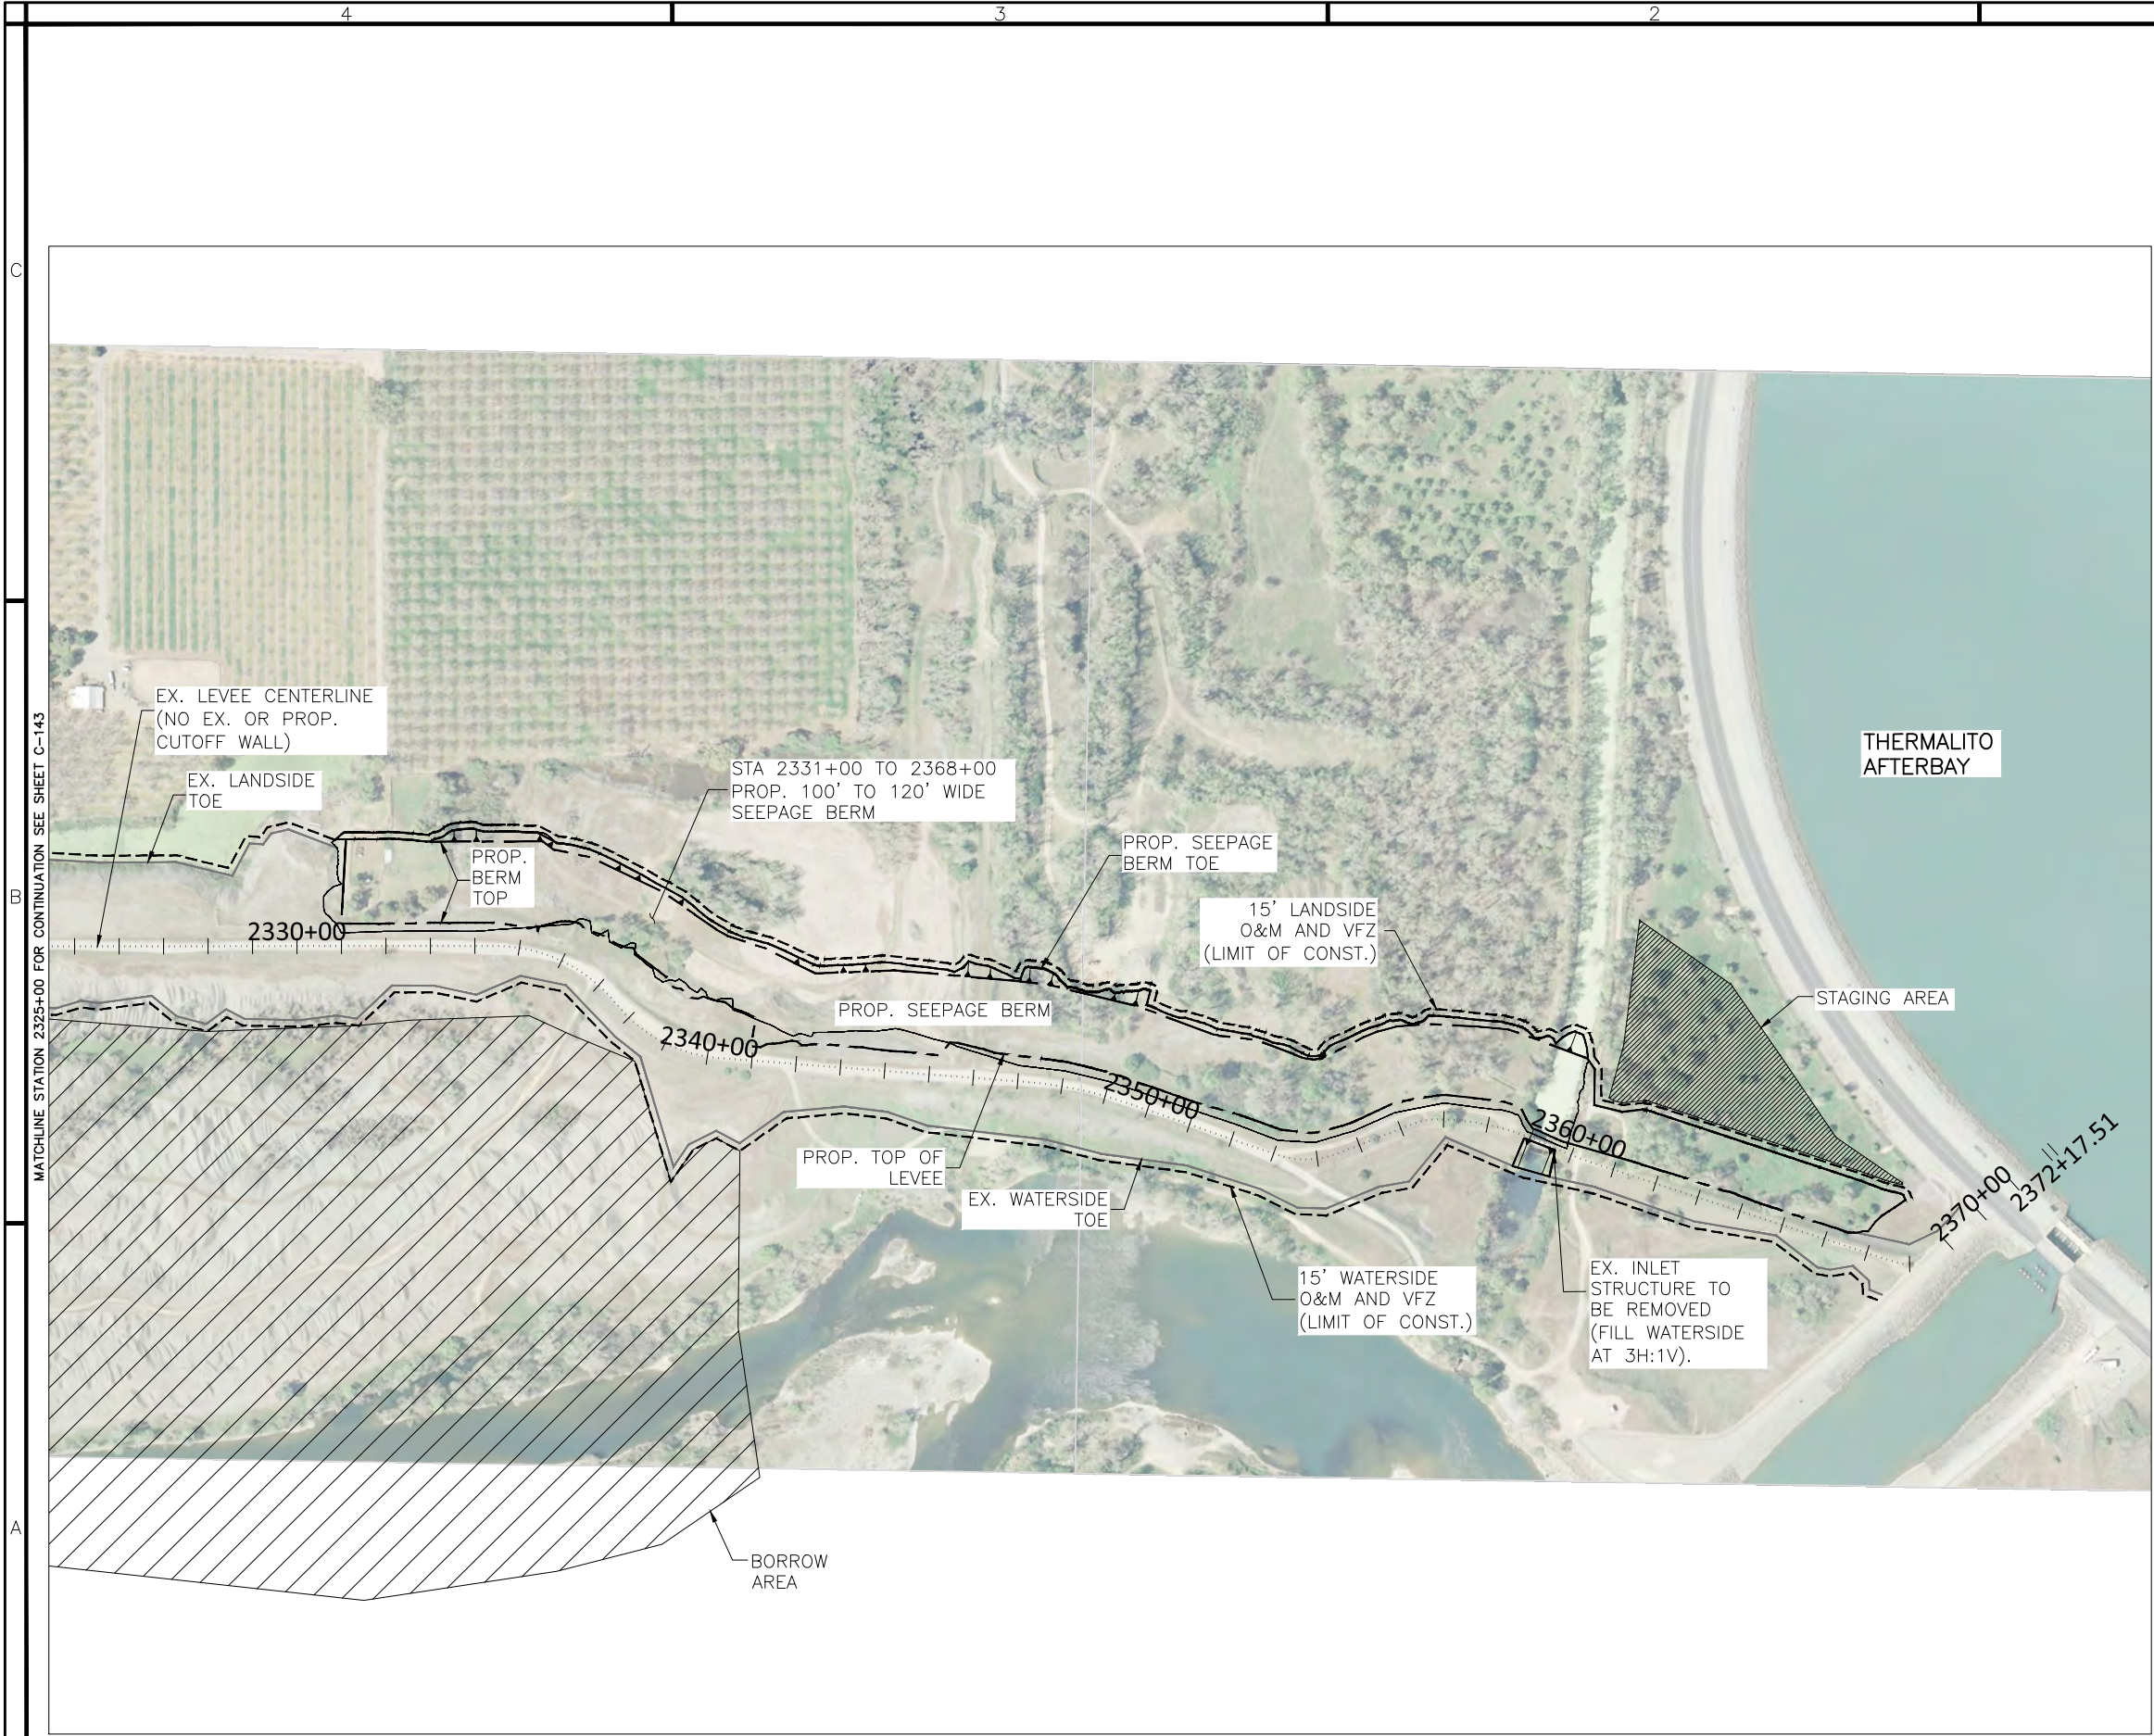
DEPARTMENT OF THE ARMY
CORPS OF ENGINEERS
SACRAMENTO, CALIFORNIA

SACRAMENTO DISTRICT
HOUSE DESIGN
1325 J STREET
SACRAMENTO, CA 95814-2922



SUTTER & BUTTE COUNTY CALIFORNIA
SUTTER BASIN PILOT FEASIBILITY STUDY
DRAFT REPORT
ALTERNATIVE SB-8
PLAN VIEW
STA 1575+00 TO 1625+00

Sheet reference number:
C-129



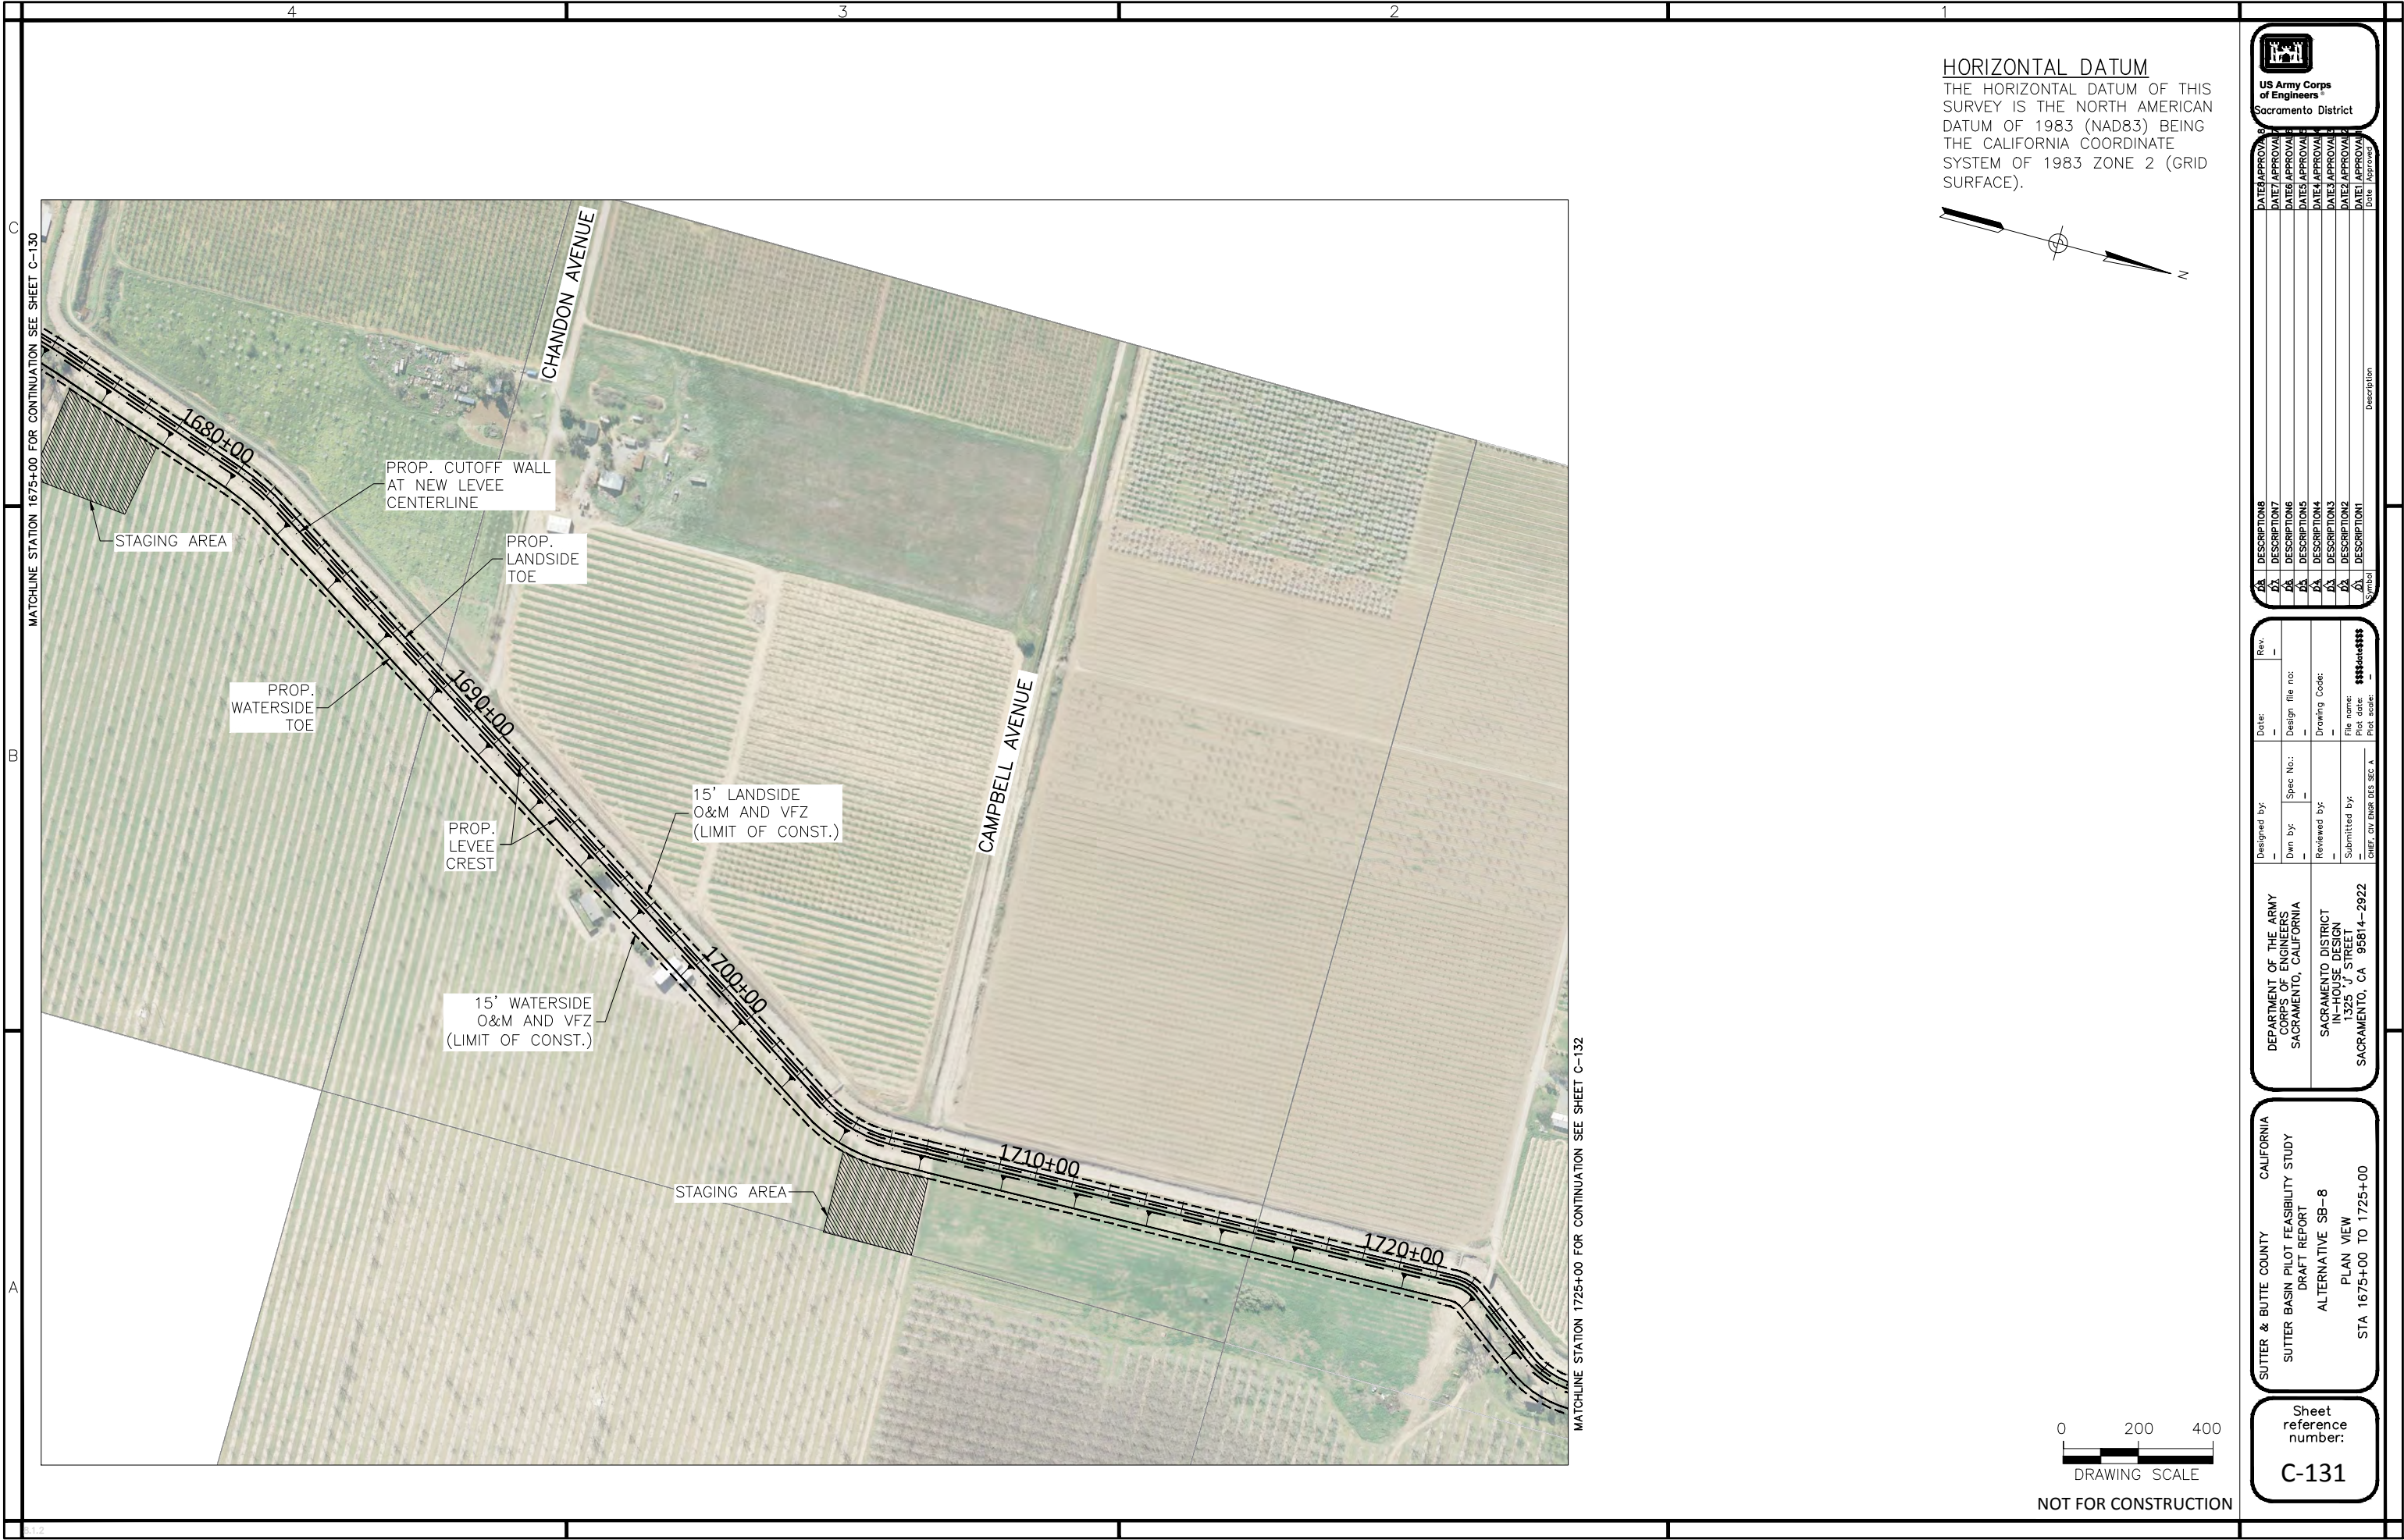

HORIZONTAL DATUM
THE HORIZONTAL DATUM OF THIS SURVEY IS THE NORTH AMERICAN DATUM OF 1983 (NAD83) BEING THE CALIFORNIA COORDINATE SYSTEM OF 1983 ZONE 2 (GRID SURFACE).

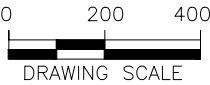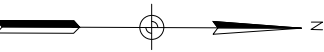

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US Army Corps
of Engineers
Sacramento District

DATE	APPROVAL	DESCRIPTION	Rev.
DATE1	APPROVAL	DESCRIPTION1	Rev.
DATE2	APPROVAL	DESCRIPTION2	Rev.
DATE3	APPROVAL	DESCRIPTION3	Rev.
DATE4	APPROVAL	DESCRIPTION4	Rev.
DATE5	APPROVAL	DESCRIPTION5	Rev.
DATE6	APPROVAL	DESCRIPTION6	Rev.
DATE7	APPROVAL	DESCRIPTION7	Rev.
DATE8	APPROVAL	DESCRIPTION8	Rev.

Designed by: _____ Date: _____

Dwn by: _____ Design file no: _____

Reviewed by: _____ Drawing Code: _____

Submitted by: _____ File name: \$\$\$\$Mat\$\$\$\$

CHEF, CIV ENR SES SEC A Plot scale: _____

DEPARTMENT OF THE ARMY
CORPS OF ENGINEERS
SACRAMENTO, CALIFORNIA

SACRAMENTO DISTRICT
HOUSE DESIGN
1325 J STREET
SACRAMENTO, CA 95814-2922

SUTTER & BUTTE COUNTY CALIFORNIA
SUTTER BASIN PILOT FEASIBILITY STUDY
DRAFT REPORT
ALTERNATIVE SB-8
PLAN VIEW
STA 2325+00 TO 2368+00

Sheet
reference
number:
C-144

C


B

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VERTICAL DATUM
THE VERTICAL DATUM OF THIS SURVEY IS THE NORTH AMERICAN VERTICAL DATUM OF 1988 (NAVD88) BEING BASED ON NATIONAL GEODETIC SURVEY (NGS) POINTS LISTED AND DERIVED BY GLOBAL POSITIONING SYSTEM (GPS) STATIC METHOD.



DATE	APPROVAL	DESCRIPTION
		DESCRIPTION 8
		DESCRIPTION 7
		DESCRIPTION 6
		DESCRIPTION 5
		DESCRIPTION 4
		DESCRIPTION 3
		DESCRIPTION 2
		DESCRIPTION 1
		Symbol
		Description

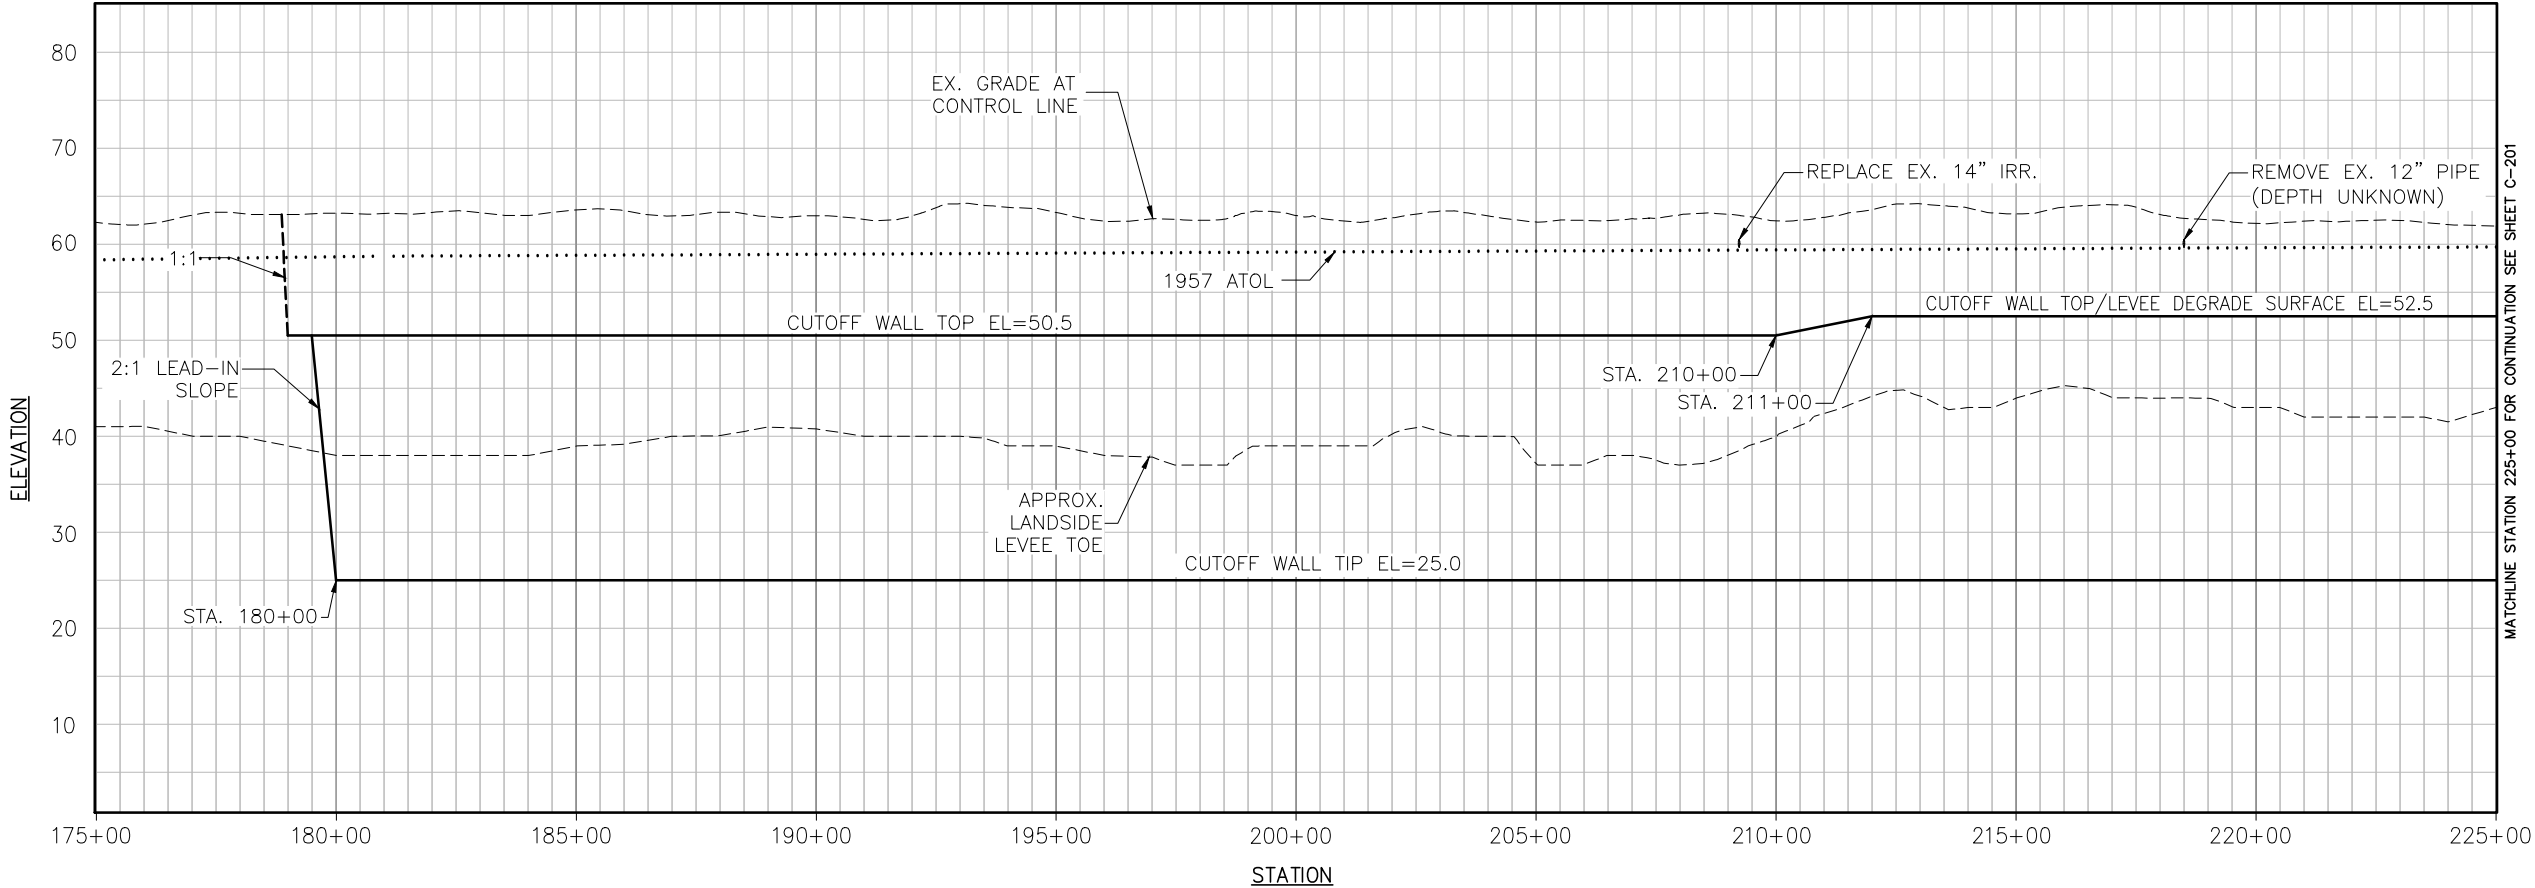

PROFILE

PROFILE
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V: 1"=10'

0 200 400

NOT FOR CONSTRUCTION


Designed by:	Date:	Rev.
Dwn by:	Design file no:	
Reviewed by:	Drawing Code:	
Submitted by:	File name:	
	Plot date:	
	Plot scale:	

DEPARTMENT OF THE ARMY
CORPS OF ENGINEERS
SACRAMENTO, CALIFORNIA


SACRAMENTO DISTRICT
HIGHWAY DESIGN
1325 J STREET
SACRAMENTO, CA 95814-2922

SUTTER & BUTTE COUNTY CALIFORNIA
SUTTER BASIN PILOT FEASIBILITY STUDY
DRAFT REPORT
ALTERNATIVE SB-7 AND SB-8
PROFILE VIEW
STA 175+00 TO 225+00

Sheet reference number:
C-201

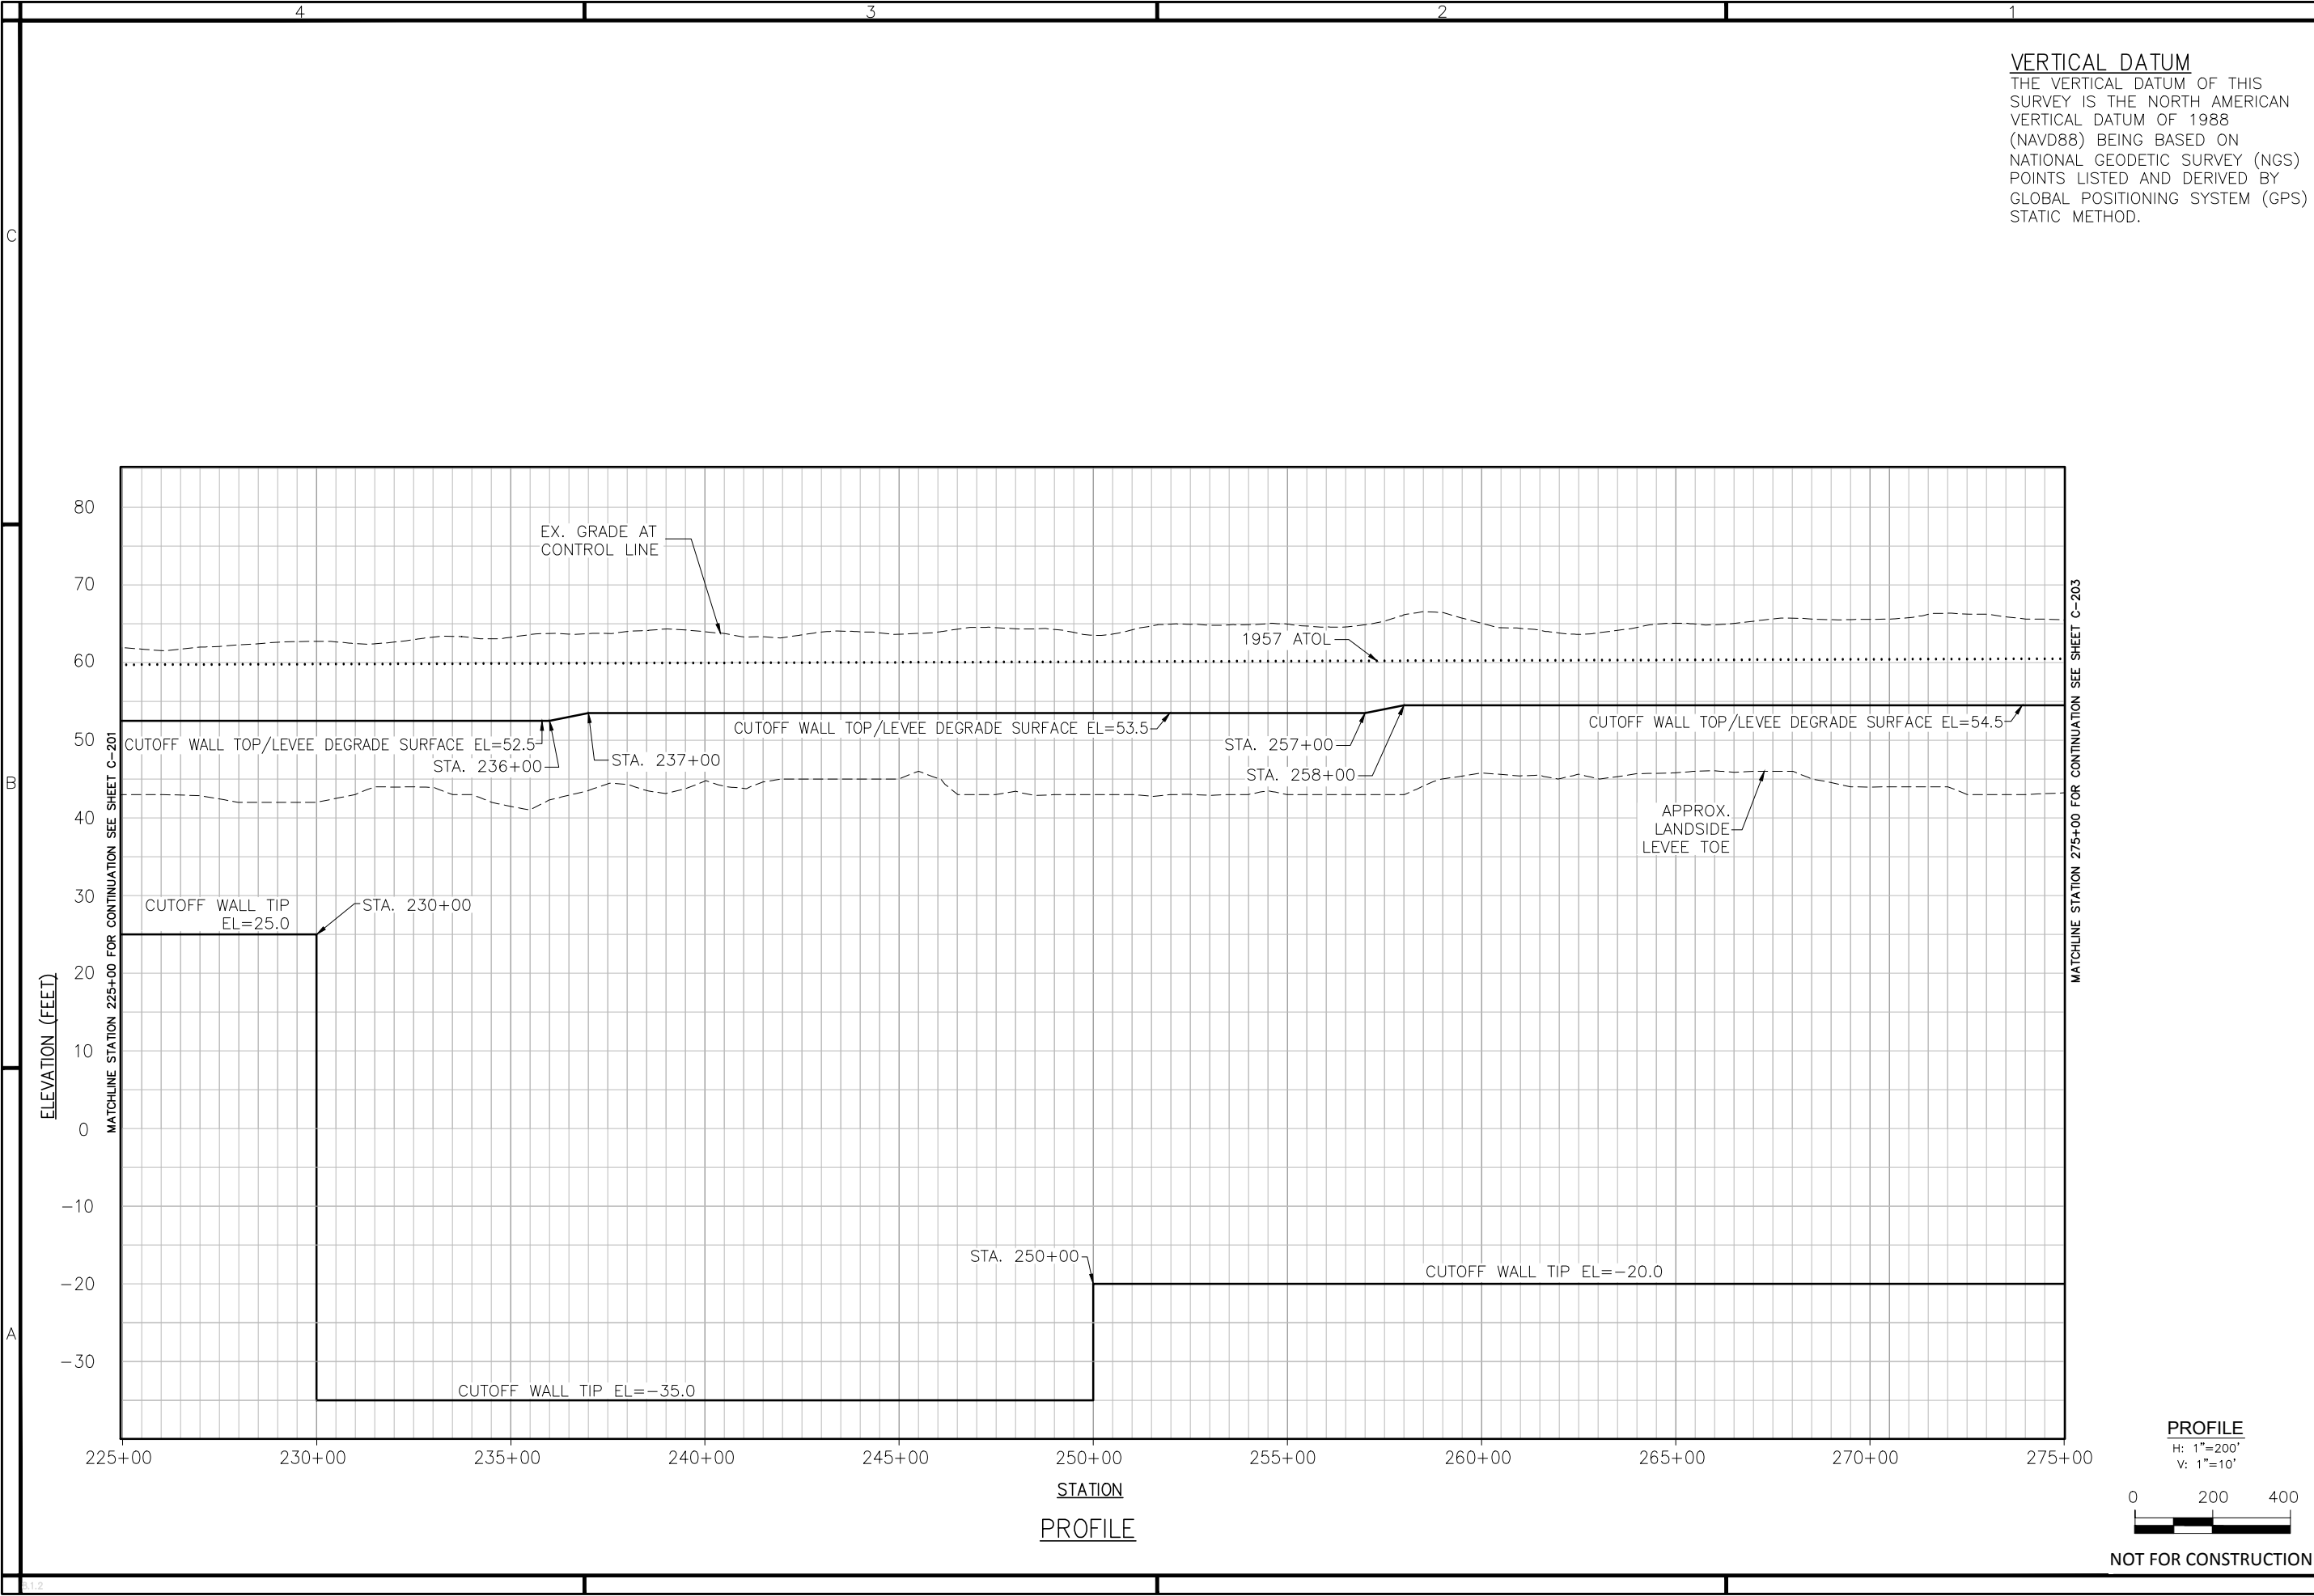

VERTICAL DATUM
THE VERTICAL DATUM OF THIS SURVEY IS THE NORTH AMERICAN VERTICAL DATUM OF 1988 (NAVD88) BEING BASED ON NATIONAL GEODETIC SURVEY (NGS) POINTS LISTED AND DERIVED BY GLOBAL POSITIONING SYSTEM (GPS) STATIC METHOD.



US Army Corps of Engineers
Sacramento District

DATE	APPROVAL	DESCRIPTION
	DATE7 APPROVAL	DESCRIPTION7
	DATE6 APPROVAL	DESCRIPTION6
	DATE5 APPROVAL	DESCRIPTION5
	DATE4 APPROVAL	DESCRIPTION4
	DATE3 APPROVAL	DESCRIPTION3
	DATE2 APPROVAL	DESCRIPTION2
	DATE1 APPROVAL	DESCRIPTION1
	DATE	DESCRIPTION

Designed by: _____

Dwn by: _____

Reviewed by: _____

Submitted by: _____

Chief, CIV ENR SES SEC A

Date: _____

Design file no: _____

Drawing Code: _____

File name: \$\$\$\$

Plot date: _____

Plot scale: _____

DEPARTMENT OF THE ARMY
CORPS OF ENGINEERS
SACRAMENTO, CALIFORNIA

SACRAMENTO DISTRICT
SACRAMENTO DESIGN
1325 J STREET
SACRAMENTO, CA 95814-2922


SUTTER & BUTTE COUNTY CALIFORNIA


SUTTER BASIN PILOT FEASIBILITY STUDY
DRAFT REPORT

ALTERNATIVE SB-7 AND SB-8

PROFILE VIEW
STA 225+00 TO 275+00

Sheet reference number:
C-202

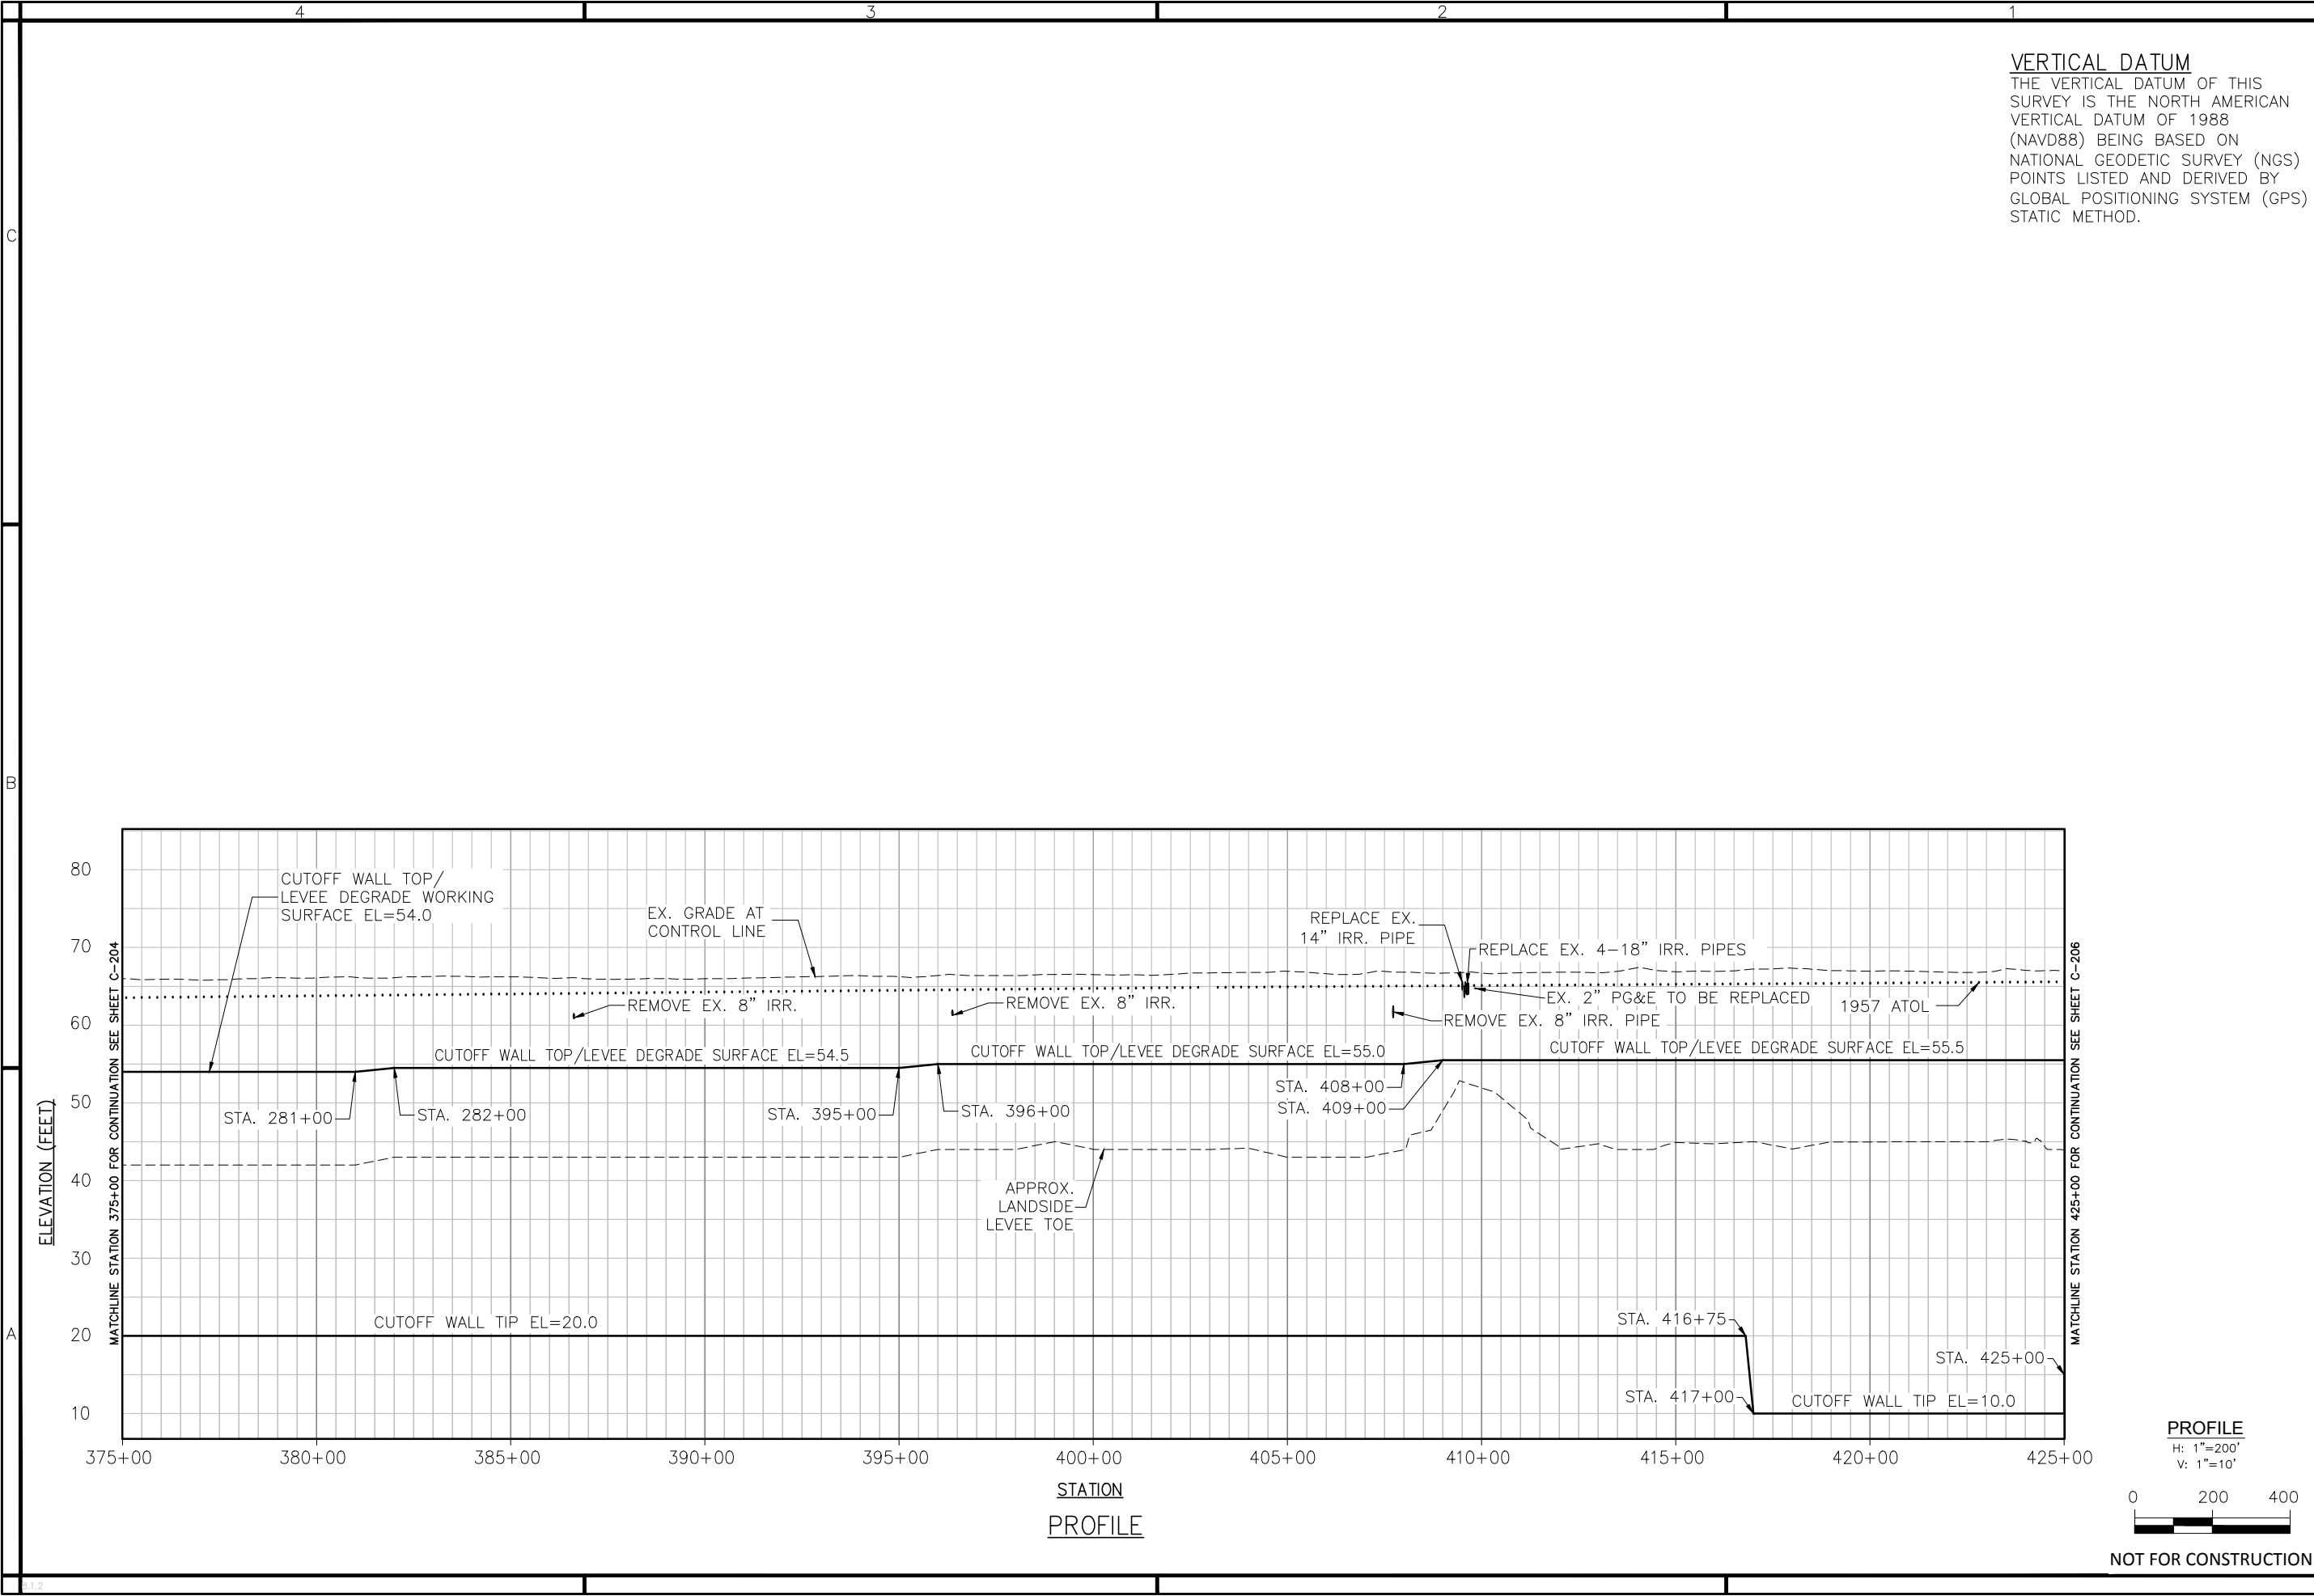



US Army Corps
of Engineers
Sacramento District

Rev.	Date	Rev.
DATE APPROVAL		
DESCRIPTION 7		
DESCRIPTION 6		
DESCRIPTION 5		
DESCRIPTION 4		
DESCRIPTION 3		
DESCRIPTION 2		
DESCRIPTION 1		
Symbol		Description

DESIGNED BY: _____

DRAWN BY: _____

REVIEWED BY: _____

SUBMITTED BY: _____

CHECKED BY: _____

DATE: _____

DESIGN FILE NO: _____

DRAWING CODE: _____

FILE NAME: _____

PLOT DATE: _____

PLOT SCALE: _____

DEPARTMENT OF THE ARMY
CORPS OF ENGINEERS
SACRAMENTO, CALIFORNIA

SACRAMENTO DISTRICT
IN-HOUSE DESIGN
1325 J STREET
SACRAMENTO, CA 95814-2922


SUTTER & BUTTE COUNTY CALIFORNIA


SUTTER BASIN PILOT FEASIBILITY STUDY
DRAFT REPORT

ALTERNATIVE SB-7 AND SB-8
PROFILE VIEW
STA 375+00 TO 425+00

Sheet
reference
number:

C-205

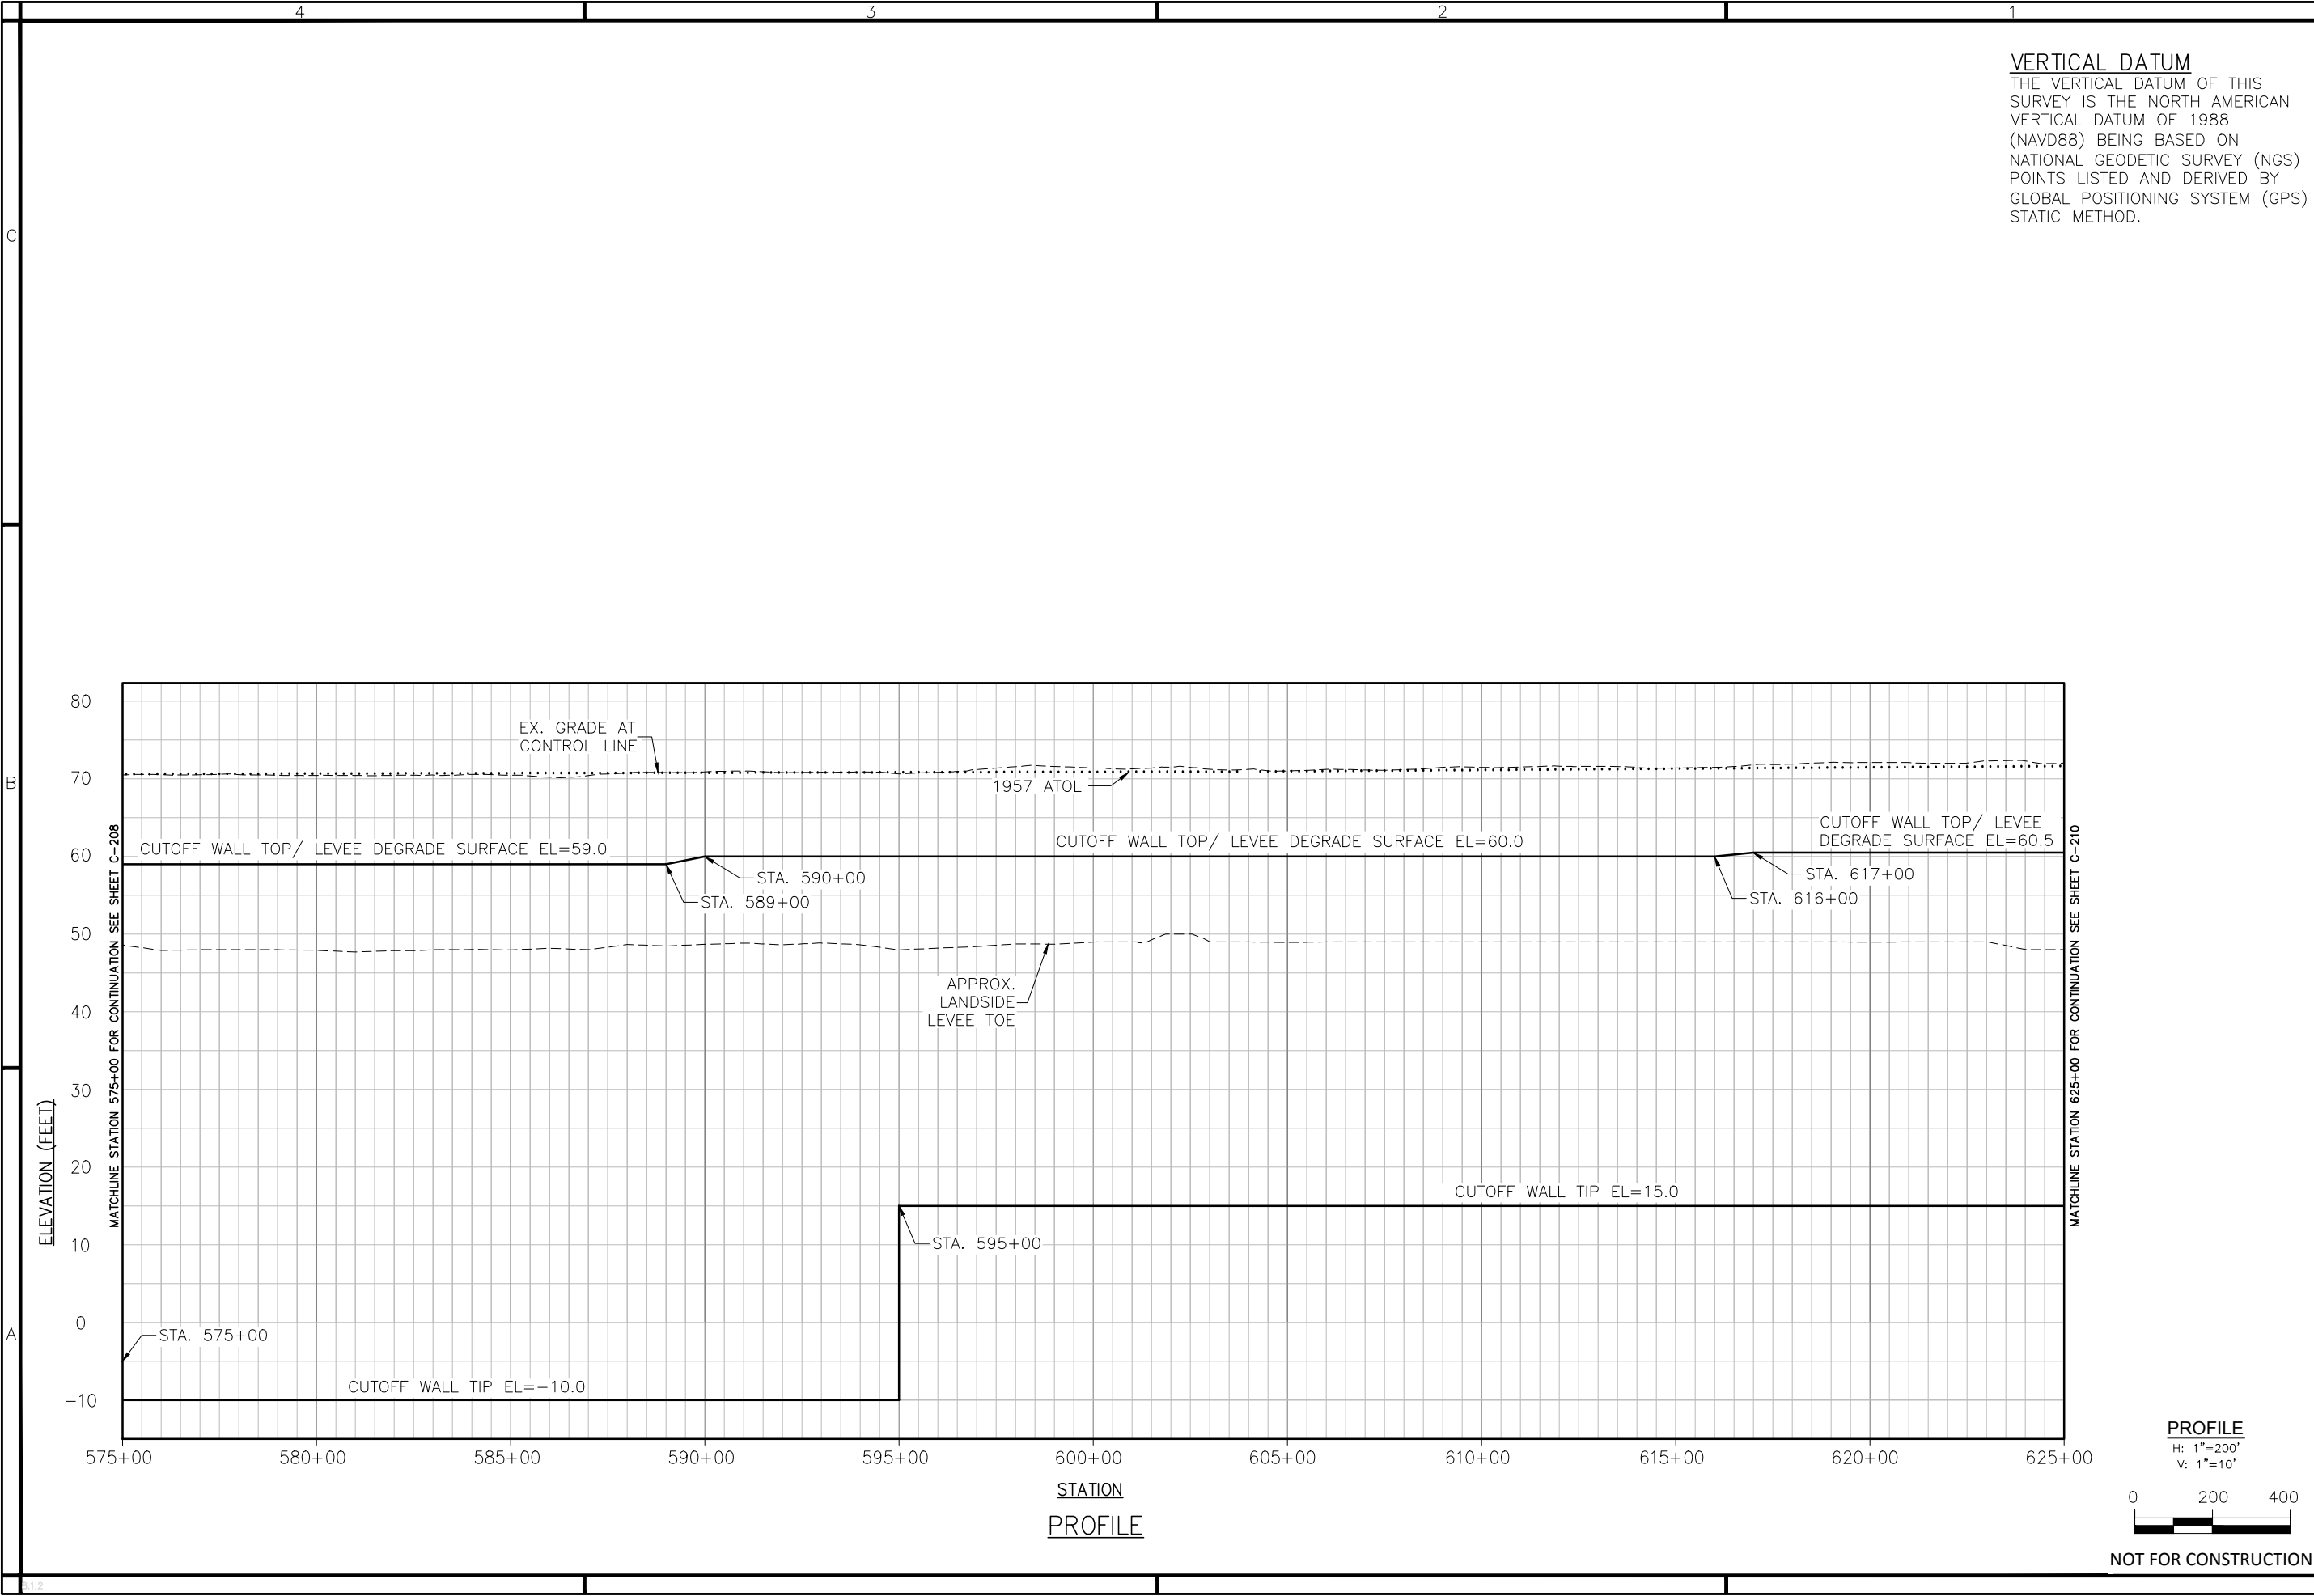



US Army Corps
of Engineers
Sacramento District

DATE APPROVED	DESCRIPTION	DATE APPROVED	DESCRIPTION	DATE APPROVED	DESCRIPTION	DATE APPROVED	DESCRIPTION	DATE APPROVED	DESCRIPTION	DATE APPROVED	DESCRIPTION
	DESCRIPTION 8		DESCRIPTION 7		DESCRIPTION 6		DESCRIPTION 5		DESCRIPTION 4		DESCRIPTION 3
	DESCRIPTION 2		DESCRIPTION 1								

Rev.	Date	Design file no.	Spec No.	Design file no.	Drawn by	Reviewed by	Submitted by	File name	Plot date	Plot scale
								\$\$\$\$\$\$\$\$		

DEPARTMENT OF THE ARMY
CORPS OF ENGINEERS
SACRAMENTO, CALIFORNIA

SACRAMENTO DISTRICT
IN-HOUSE DESIGN
1325 J STREET
SACRAMENTO, CA 95814-2922


SUTTER & BUTTE COUNTY CALIFORNIA


SUTTER BASIN PILOT FEASIBILITY STUDY
DRAFT REPORT


ALTERNATIVE SB-7 AND SB-8
PROFILE VIEW
STA 575+00 TO 625+00

Sheet
reference
number:

C-209

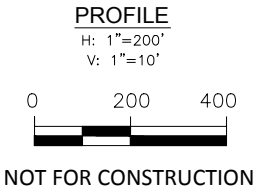

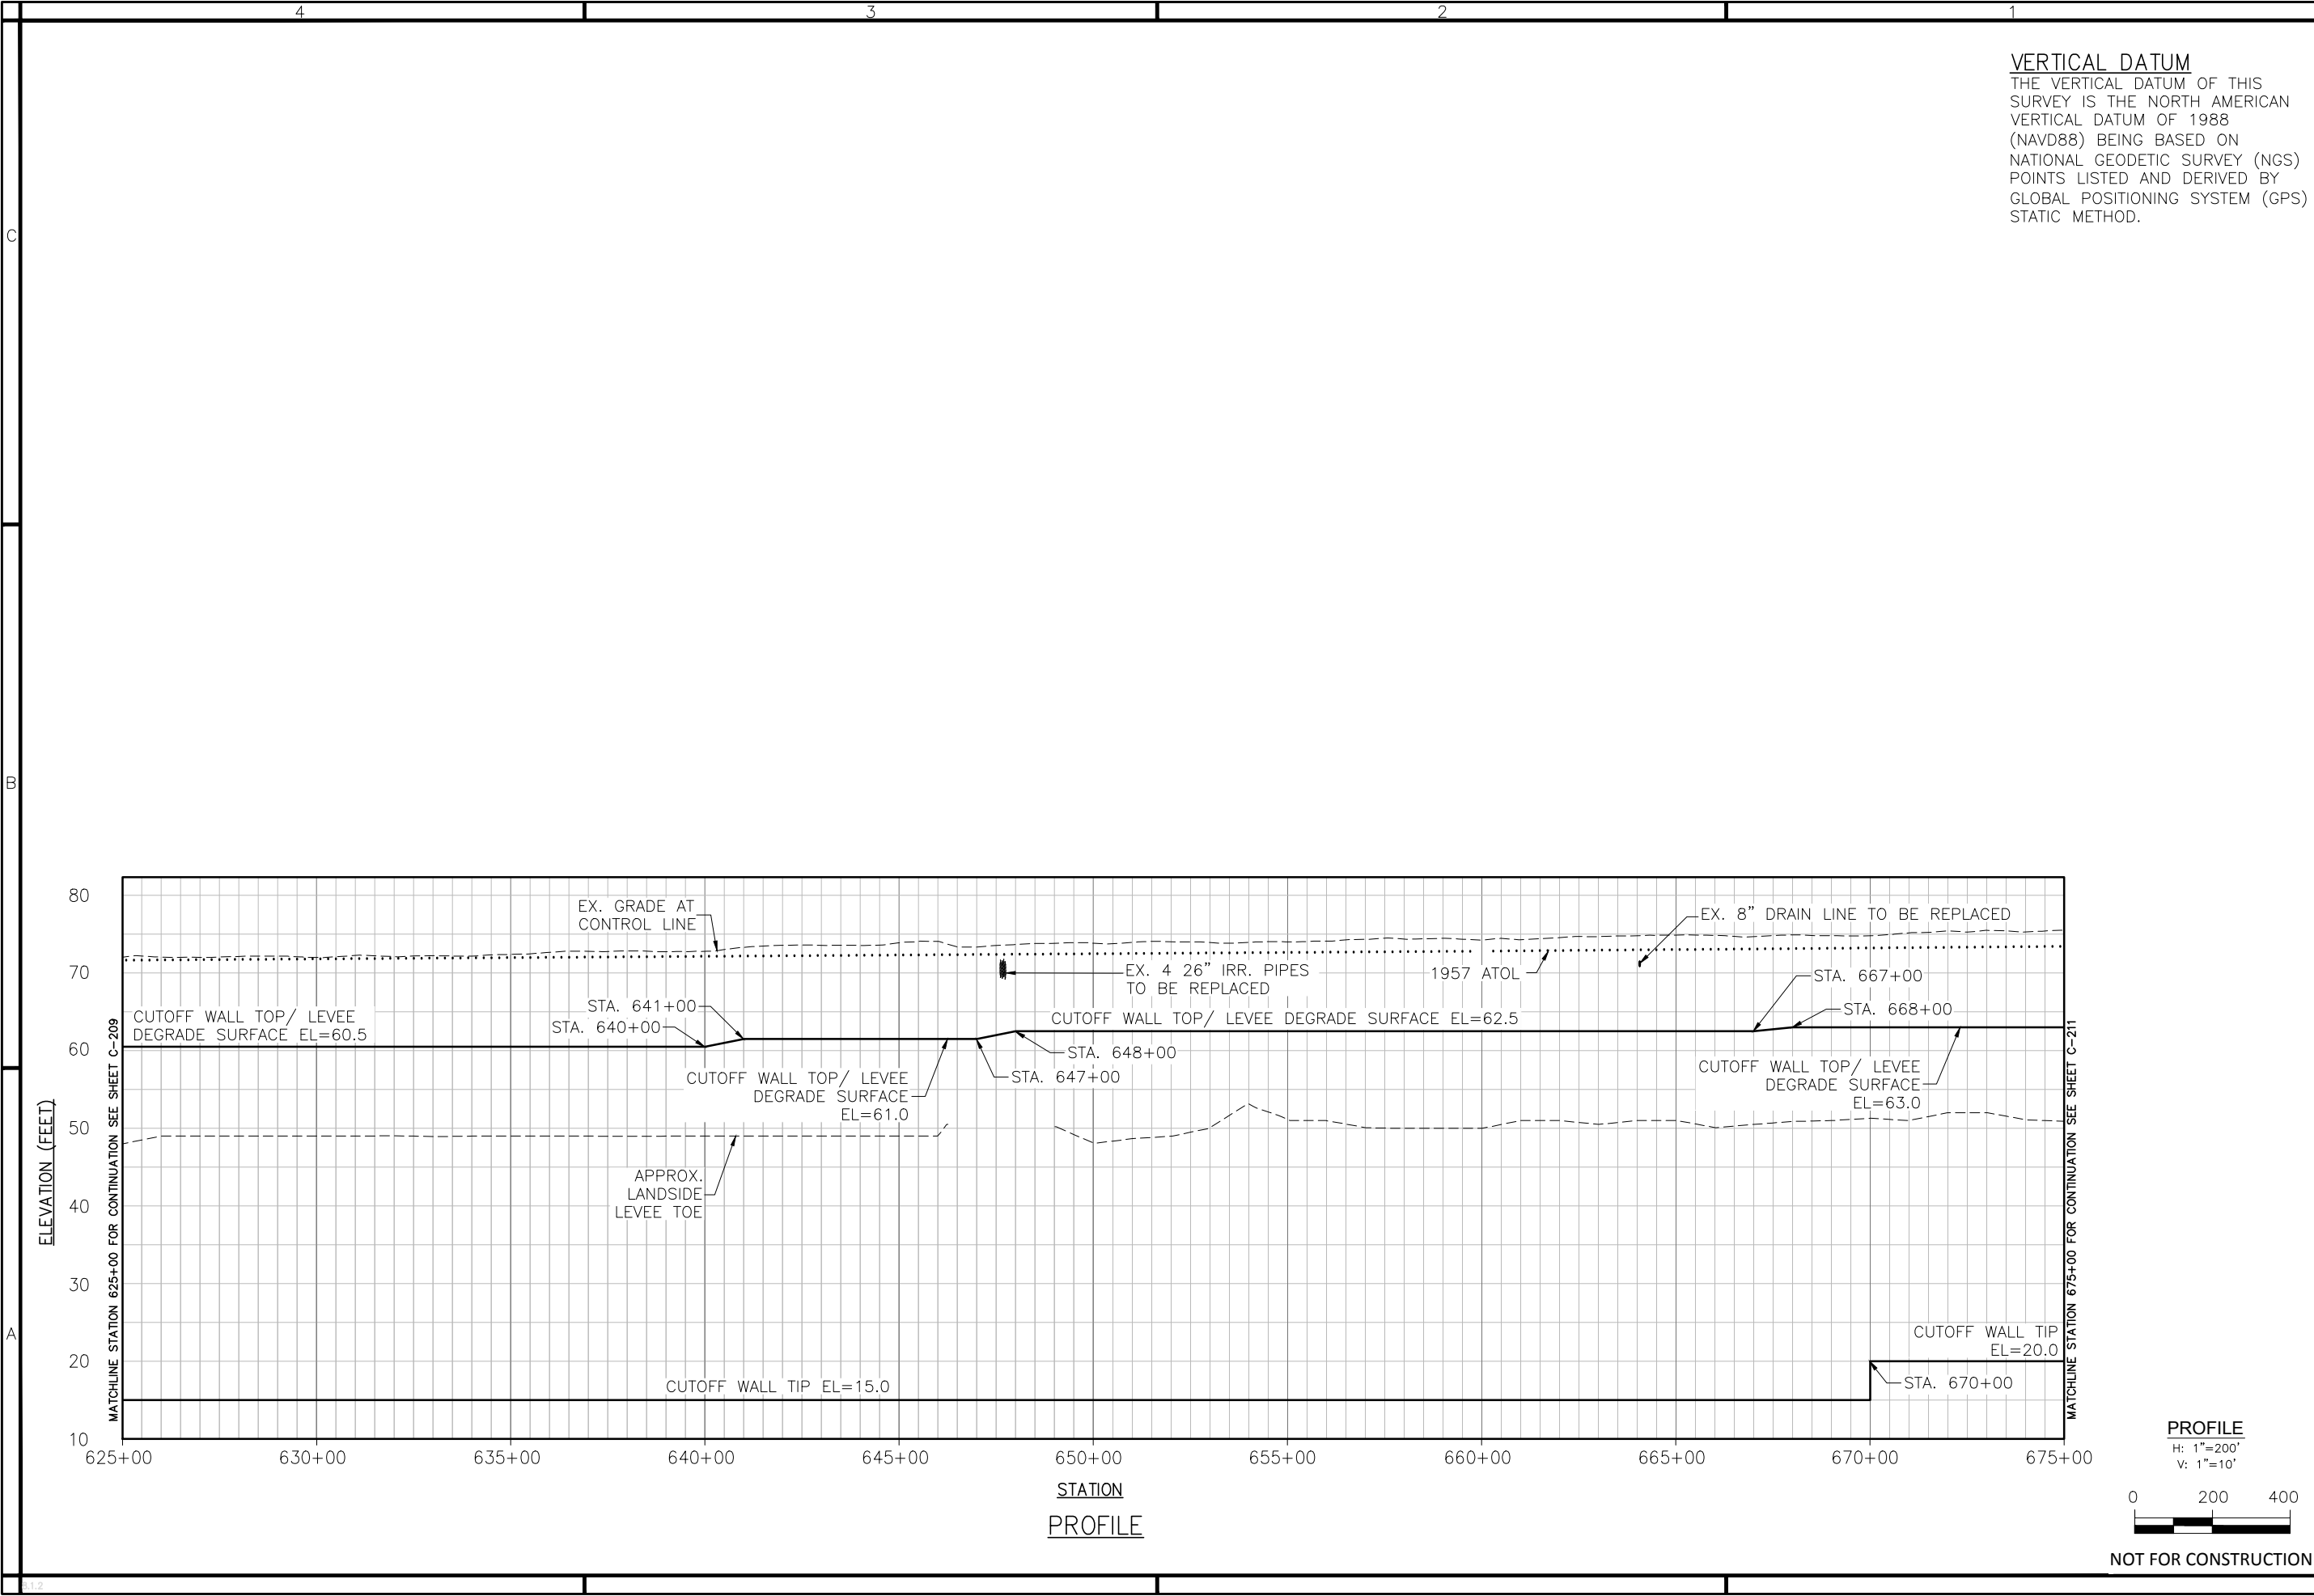



US Army Corps
of Engineers
Sacramento District

Rev.	Date	Designed by	Spec No.	Den by	Reviewed by	Submitted by	File name	Plot date	Plot scale
1							1325-1-1 STREET		
2							1325-1-1 STREET		
3							1325-1-1 STREET		
4							1325-1-1 STREET		
5							1325-1-1 STREET		
6							1325-1-1 STREET		
7							1325-1-1 STREET		
8							1325-1-1 STREET		

DEPARTMENT OF THE ARMY
CORPS OF ENGINEERS
SACRAMENTO, CALIFORNIA

SACRAMENTO DISTRICT
IN-HOUSE DESIGN
1325-1-1 STREET
SACRAMENTO, CA 95814-2922

SUTTER & BUTTE COUNTY CALIFORNIA

SUTTER BASIN PILOT FEASIBILITY STUDY
DRAFT REPORT

ALTERNATIVE SB-7 AND SB-8
PROFILE VIEW
STA 625+00 TO 675+00

Sheet
reference
number:

C-210

THE VERTICAL DATUM OF THIS SURVEY IS THE NORTH AMERICAN VERTICAL DATUM OF 1988 (NAV88) BEING BASED ON NATIONAL GEODETIC SURVEY (NGS) POINTS LISTED AND DERIVED BY GLOBAL POSITIONING SYSTEM (GPS) STATIC METHOD.




Symbol	Description	Date Approved
D1	DESCRIPTION1	DATE1 APPROVAL
D2	DESCRIPTION2	DATE2 APPROVAL
D3	DESCRIPTION3	DATE3 APPROVAL
D4	DESCRIPTION4	DATE4 APPROVAL
D5	DESCRIPTION5	DATE5 APPROVAL
D6	DESCRIPTION6	DATE6 APPROVAL
D7	DESCRIPTION7	DATE7 APPROVAL
D8	DESCRIPTION8	DATE8 APPROVAL

DEPARTMENT OF THE ARMY CORPS OF ENGINEERS SACRAMENTO, CALIFORNIA SACRAMENTO DISTRICT MILITARY ENGINEERING 1375 J STREET SACRAMENTO, CA 95814-2922	Designed by: _____		Date: _____	Rev. _____
	Drawn by: _____	Spec No.: _____	Design file no: _____	
	Reviewed by: _____		Drawing Code: _____	
	Submitted by: _____		File name: _____	
	CHECK, CIV ENGR DES SEC A		Plot date: _____ Plot scale: \$\$\$\$\$\$\$\$\$\$\$\$	

R & BUTTE COUNTY CALIFORNIA
TITTER BASIN PILOT FEASIBILITY STUDY
DRAFT REPORT
ALTERNATIVE SB-7 AND SB-8
PROFILE VIEW
STA 725+00 TO 775+00

Sheet
reference
number:
C-212

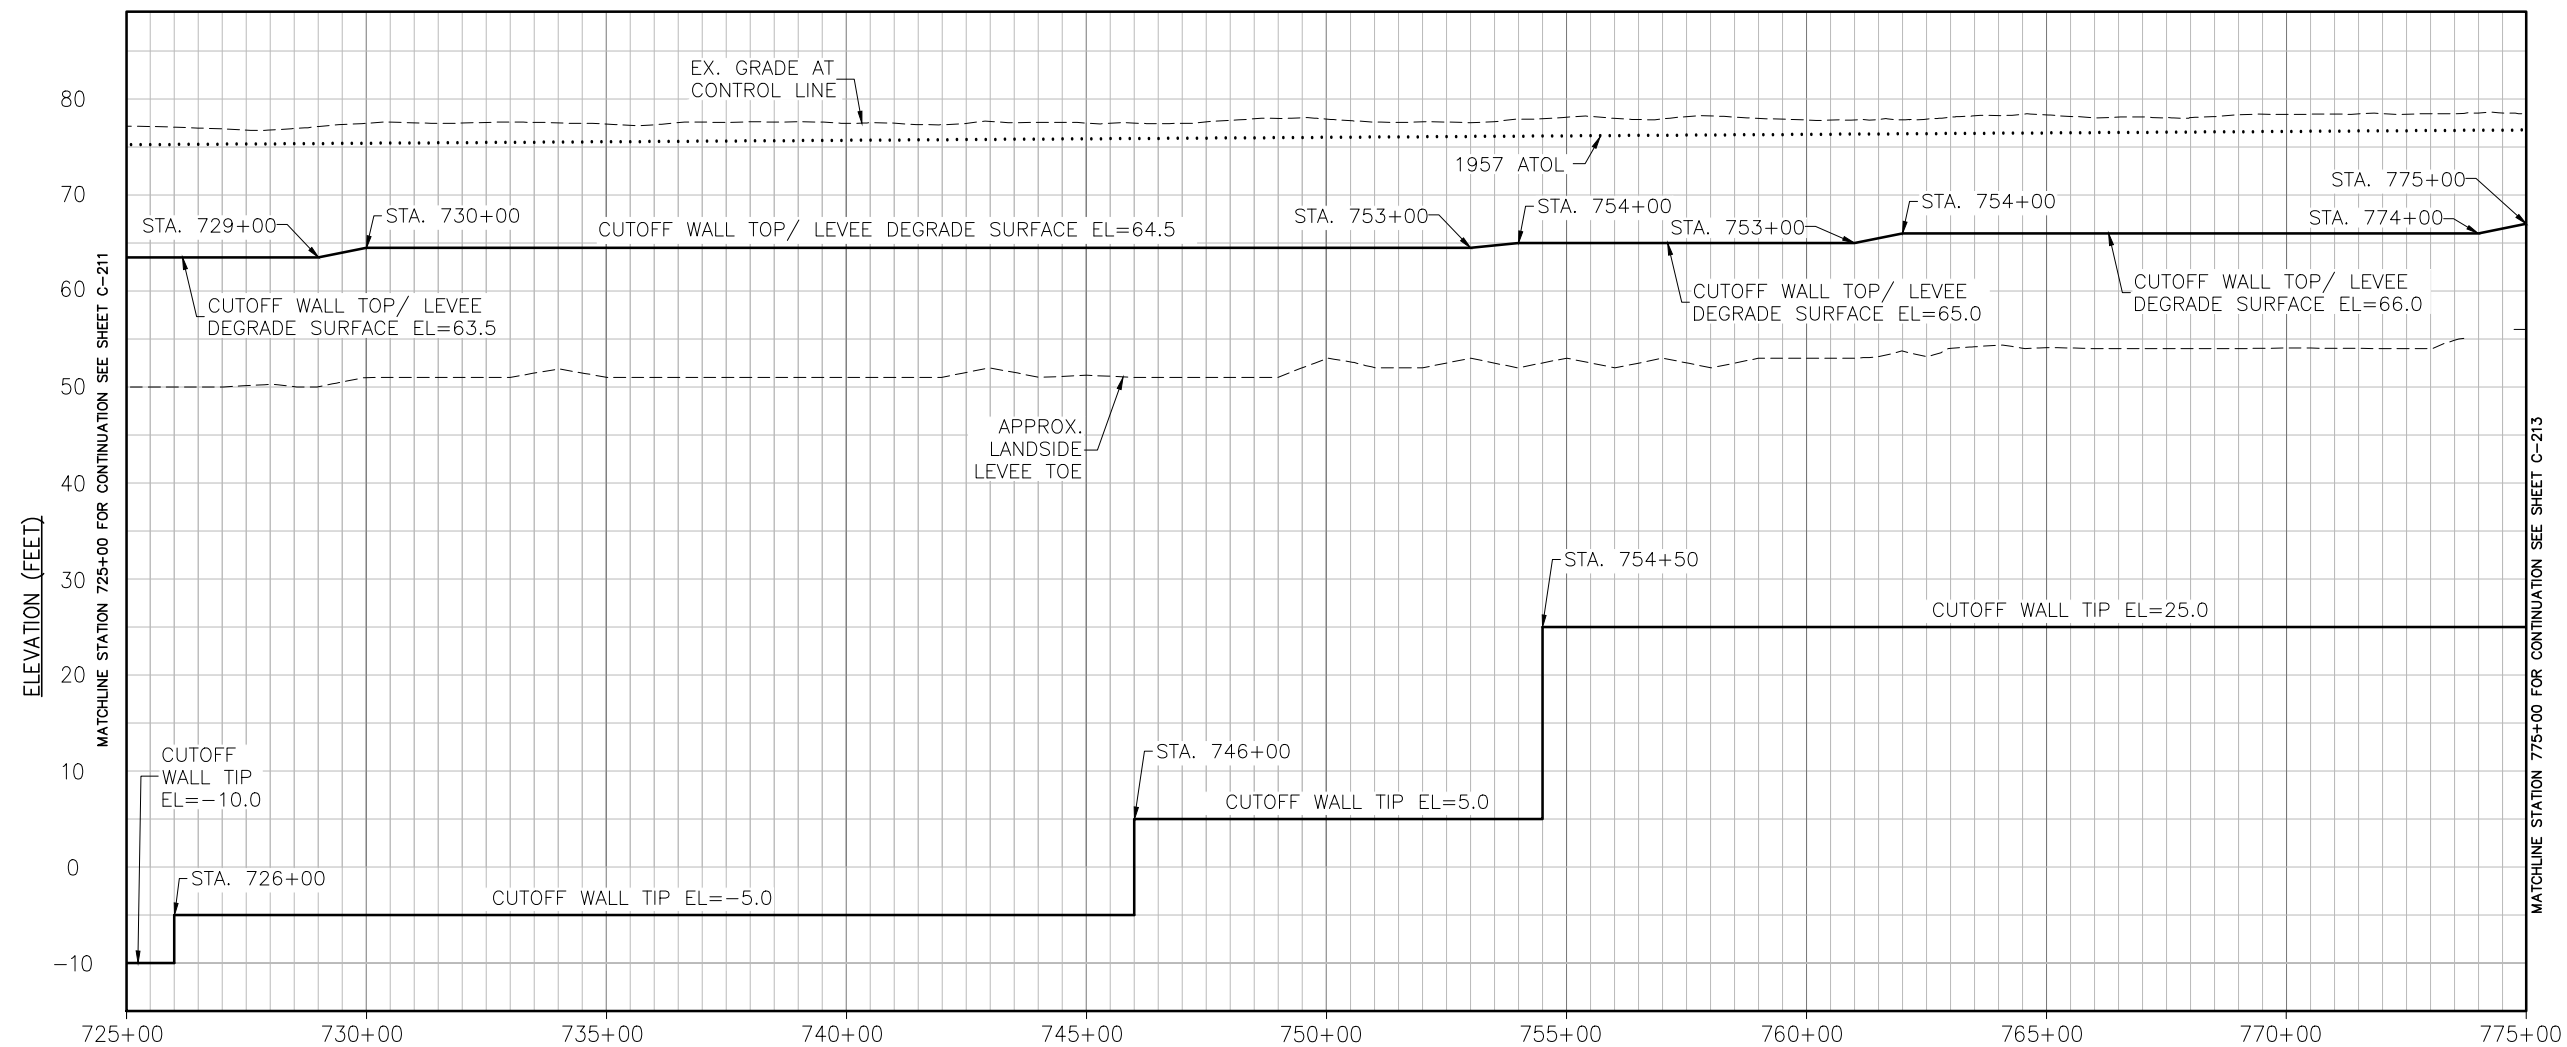


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
H: 1"=200'

V: 1"=10'



NOT FOR CONSTRUCTION



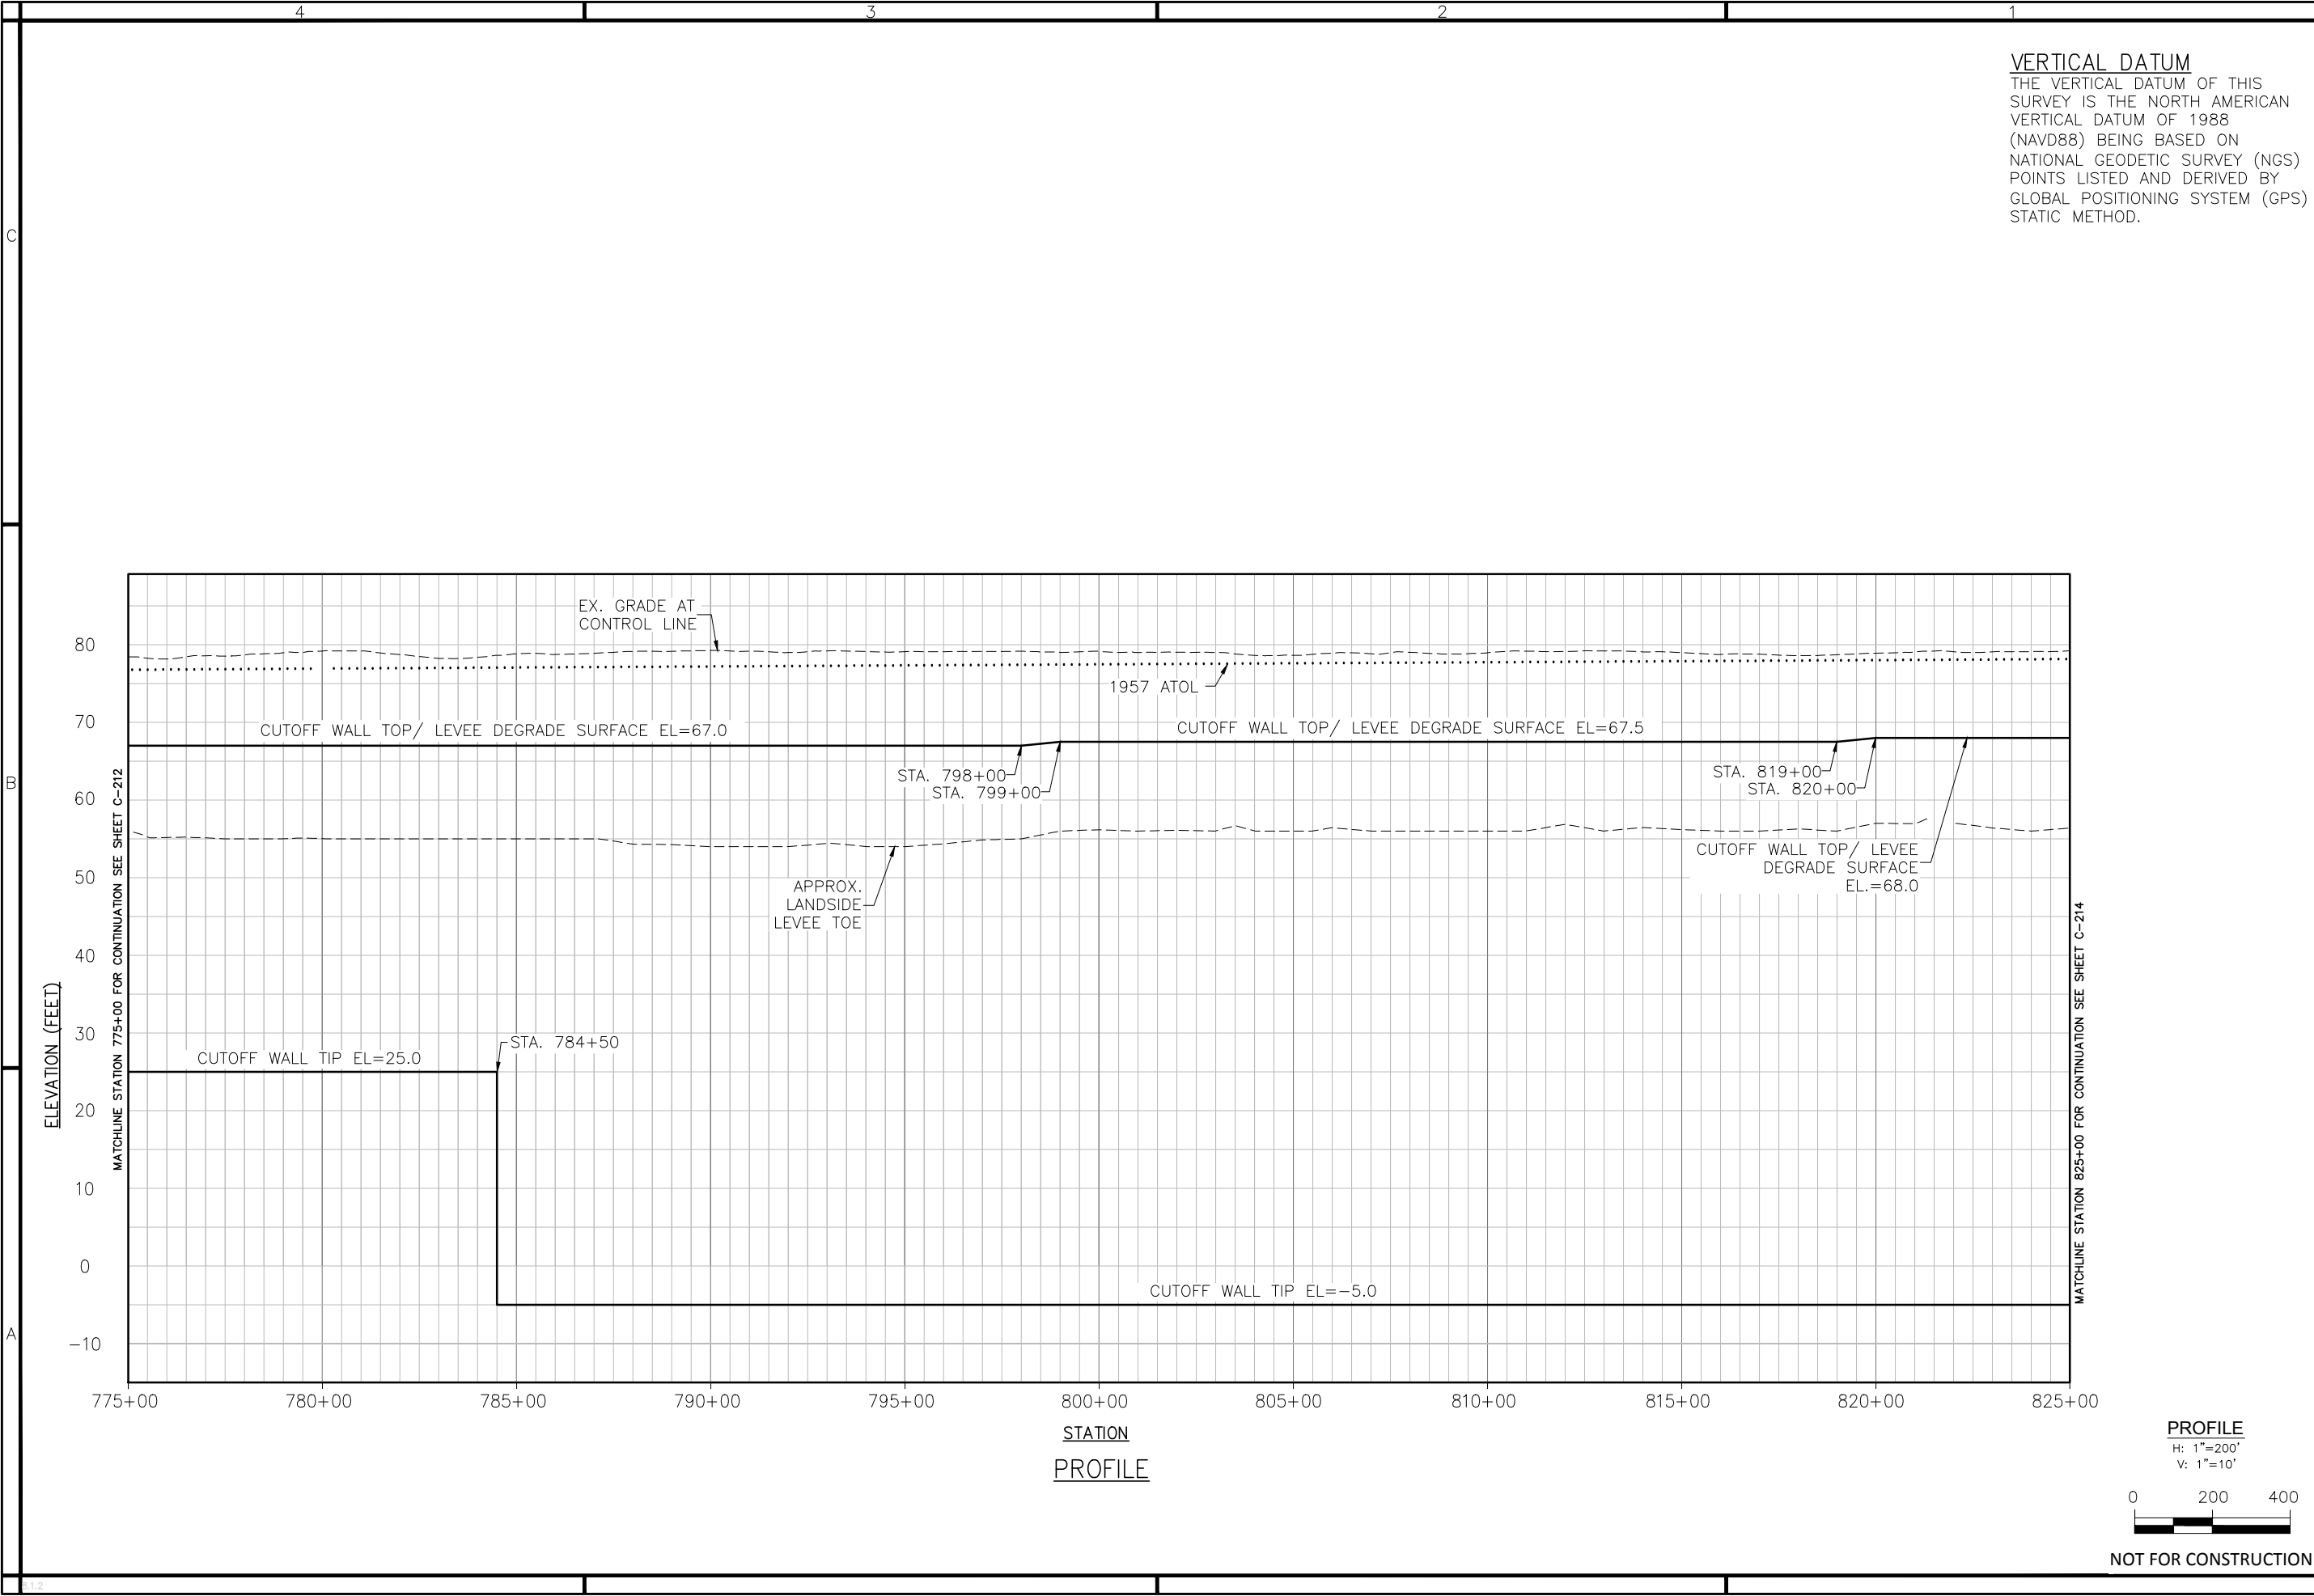

US Army Corps
of Engineers
Sacramento District

DATE	APPROVAL	DESCRIPTION
	DATE7 APPROVAL	DESCRIPTION7
	DATE6 APPROVAL	DESCRIPTION6
	DATE5 APPROVAL	DESCRIPTION5
	DATE4 APPROVAL	DESCRIPTION4
	DATE3 APPROVAL	DESCRIPTION3
	DATE2 APPROVAL	DESCRIPTION2
	DATE1 APPROVAL	DESCRIPTION1
	DATE	DESCRIPTION

Designed by:	Date:	Rev.

Spec No.:	Design file no.:


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Submitted by:	File name:	Plot date:	Plot scale:
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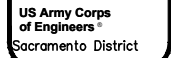
DEPARTMENT OF THE ARMY CORPS OF ENGINEERS SACRAMENTO, CALIFORNIA
SACRAMENTO DISTRICT IN-HOUSE DESIGN 1325 J STREET SACRAMENTO, CA 95814-2922

SUTTER & BUTTE COUNTY CALIFORNIA
SUTTER BASIN PILOT FEASIBILITY STUDY DRAFT REPORT ALTERNATIVE SB-7 AND SB-8 PROFILE VIEW STA 775+00 TO 825+00

Sheet reference number:
C-213



THE VERTICAL DATUM OF THIS SURVEY IS THE NORTH AMERICAN VERTICAL DATUM OF 1988 (NAVD88) BEING BASED ON NATIONAL GEODETIC SURVEY (NGS) POINTS LISTED AND DERIVED BY GLOBAL POSITIONING SYSTEM (GPS) STATIC METHOD.

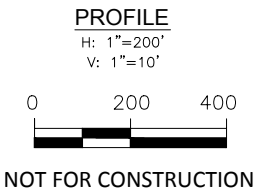


Symbol	Description	Date	Approval
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DA	DESCRIPTION2	DATE2	APPROVAL2
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DA	DESCRIPTION4	DATE4	APPROVAL4
DA	DESCRIPTION5	DATE5	APPROVAL5
DA	DESCRIPTION6	DATE6	APPROVAL6
DA	DESCRIPTION7	DATE7	APPROVAL7
DA	DESCRIPTION8	DATE8	APPROVAL8

DESIGNATED BY	DATE	REV.
DESIGNED BY	DESIGN FILE NO.	
DWN BY	SPEC NO.	
REVIEWED BY	DRAWING CODE	
SUBMITTED BY	FILE NAME	
CHECK, CIV. ENGR. DES. SEC. A	PLOT DATE	
	PLOT SCALE	

SUTTER & BUTTE COUNTY CALIFORNIA
SUTTER BASIN PILOT FEASIBILITY STUDY
DRAFT REPORT
ALTERNATIVE SB-7 AND SB-8
PROFILE VIEW
STA 825+00 TO 875+00



Sheet
reference
number:
C-214

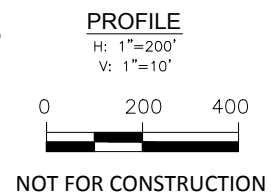


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VERTICAL DATUM
THE VERTICAL DATUM OF THIS SURVEY IS THE NORTH AMERICAN VERTICAL DATUM OF 1988 (NAVD88) BEING BASED ON NATIONAL GEODETIC SURVEY (NGS) POINTS LISTED AND DERIVED BY GLOBAL POSITIONING SYSTEM (GPS) STATIC METHOD.



US Army Corps
of Engineers
Sacramento District

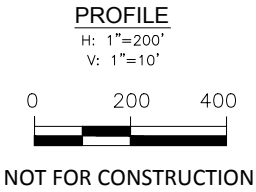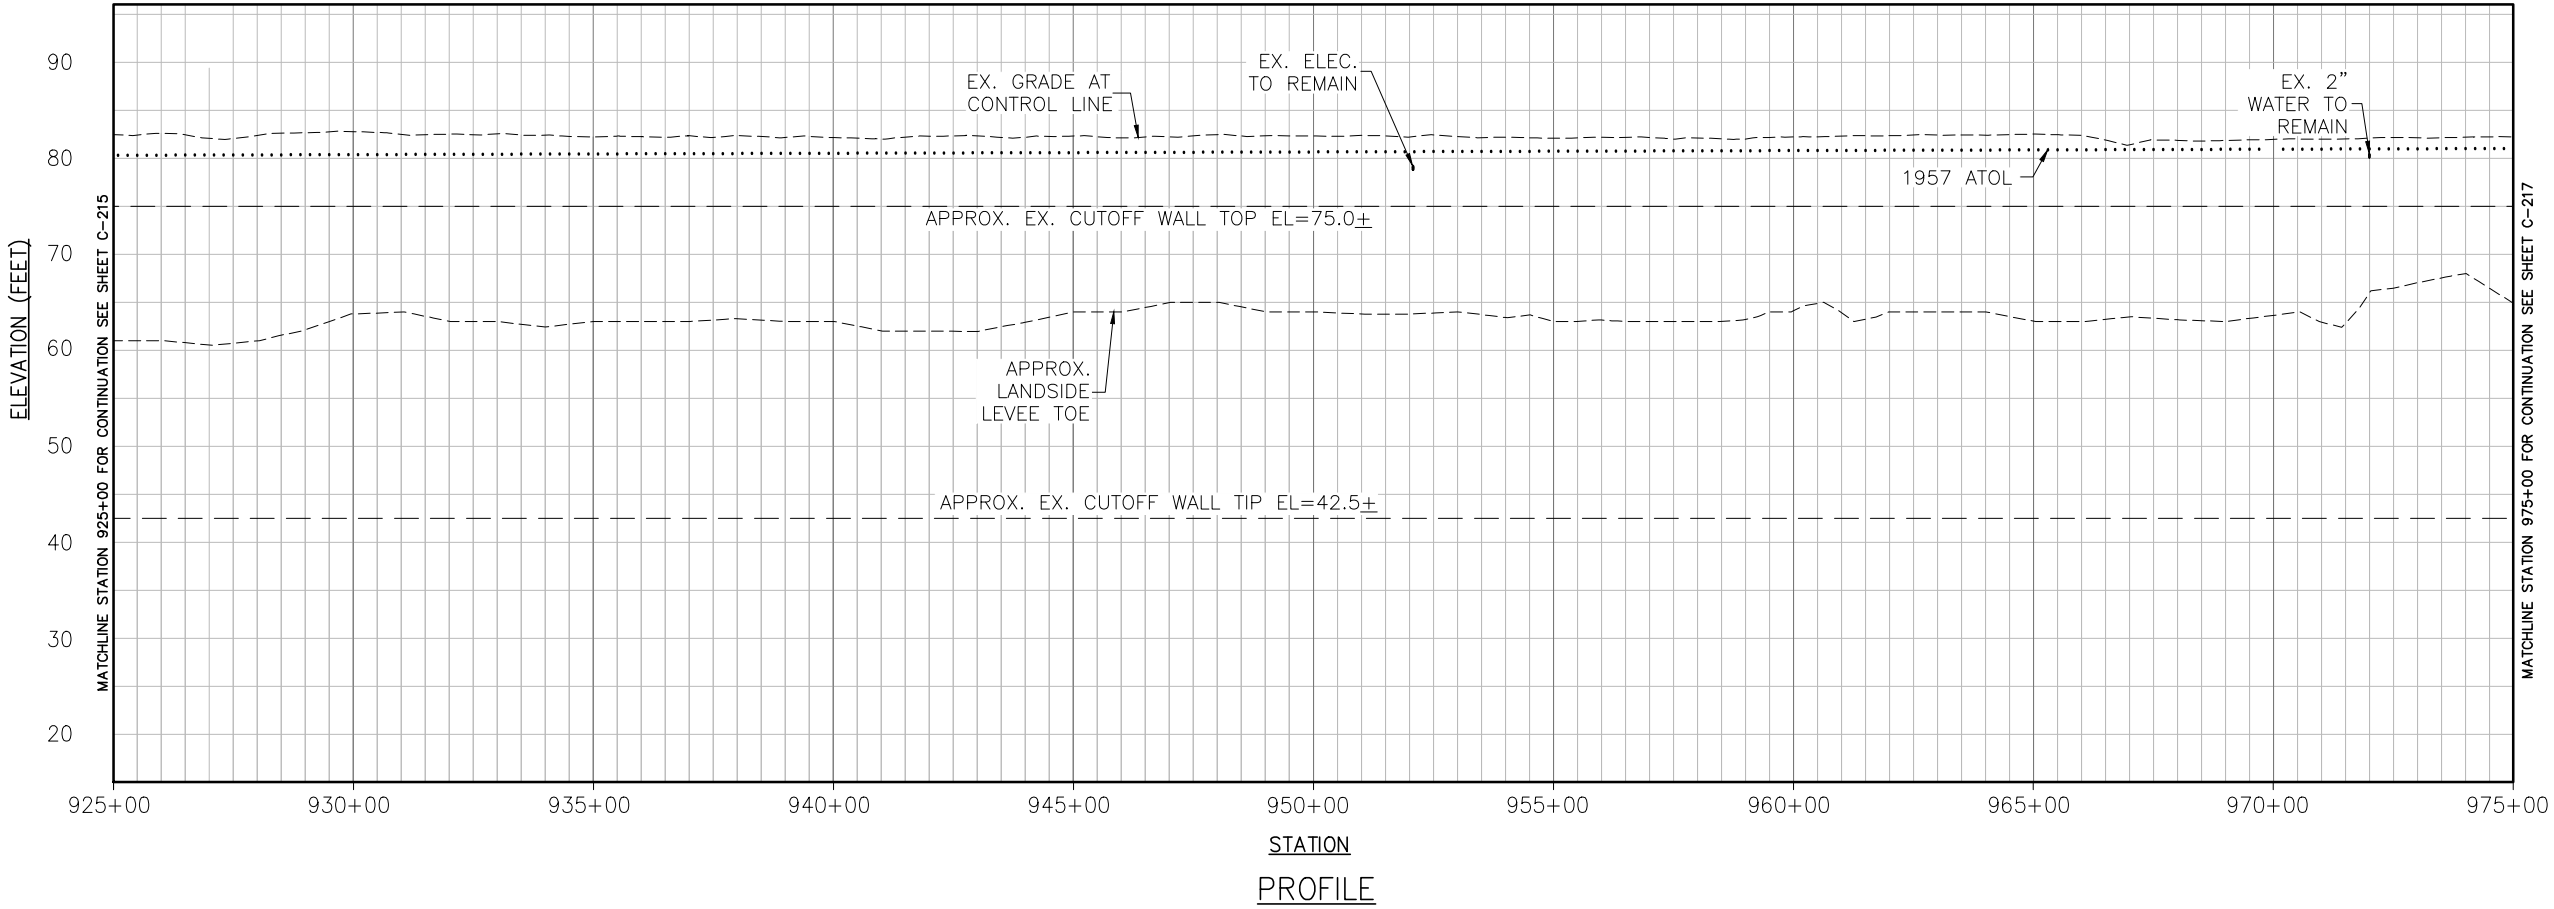DATE	APPROVAL	DESCRIPTION	Rev.
DATE7	APPROVAL	DESCRIPTION7	Rev.
DATE6	APPROVAL	DESCRIPTION6	Rev.
DATE5	APPROVAL	DESCRIPTION5	Rev.
DATE4	APPROVAL	DESCRIPTION4	Rev.
DATE3	APPROVAL	DESCRIPTION3	Rev.
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DEPARTMENT OF THE ARMY
CORPS OF ENGINEERS
SACRAMENTO, CALIFORNIA


SACRAMENTO DISTRICT
IN-HOUSE DESIGN
1325 J STREET
SACRAMENTO, CA 95814-2922

SUTTER & BUTTE COUNTY CALIFORNIA

SUTTER BASIN PILOT FEASIBILITY STUDY
DRAFT REPORT

ALTERNATIVE SB-7 AND SB-8
PROFILE VIEW
STA 925+00 TO 975+00

Sheet
reference
number:
C-216

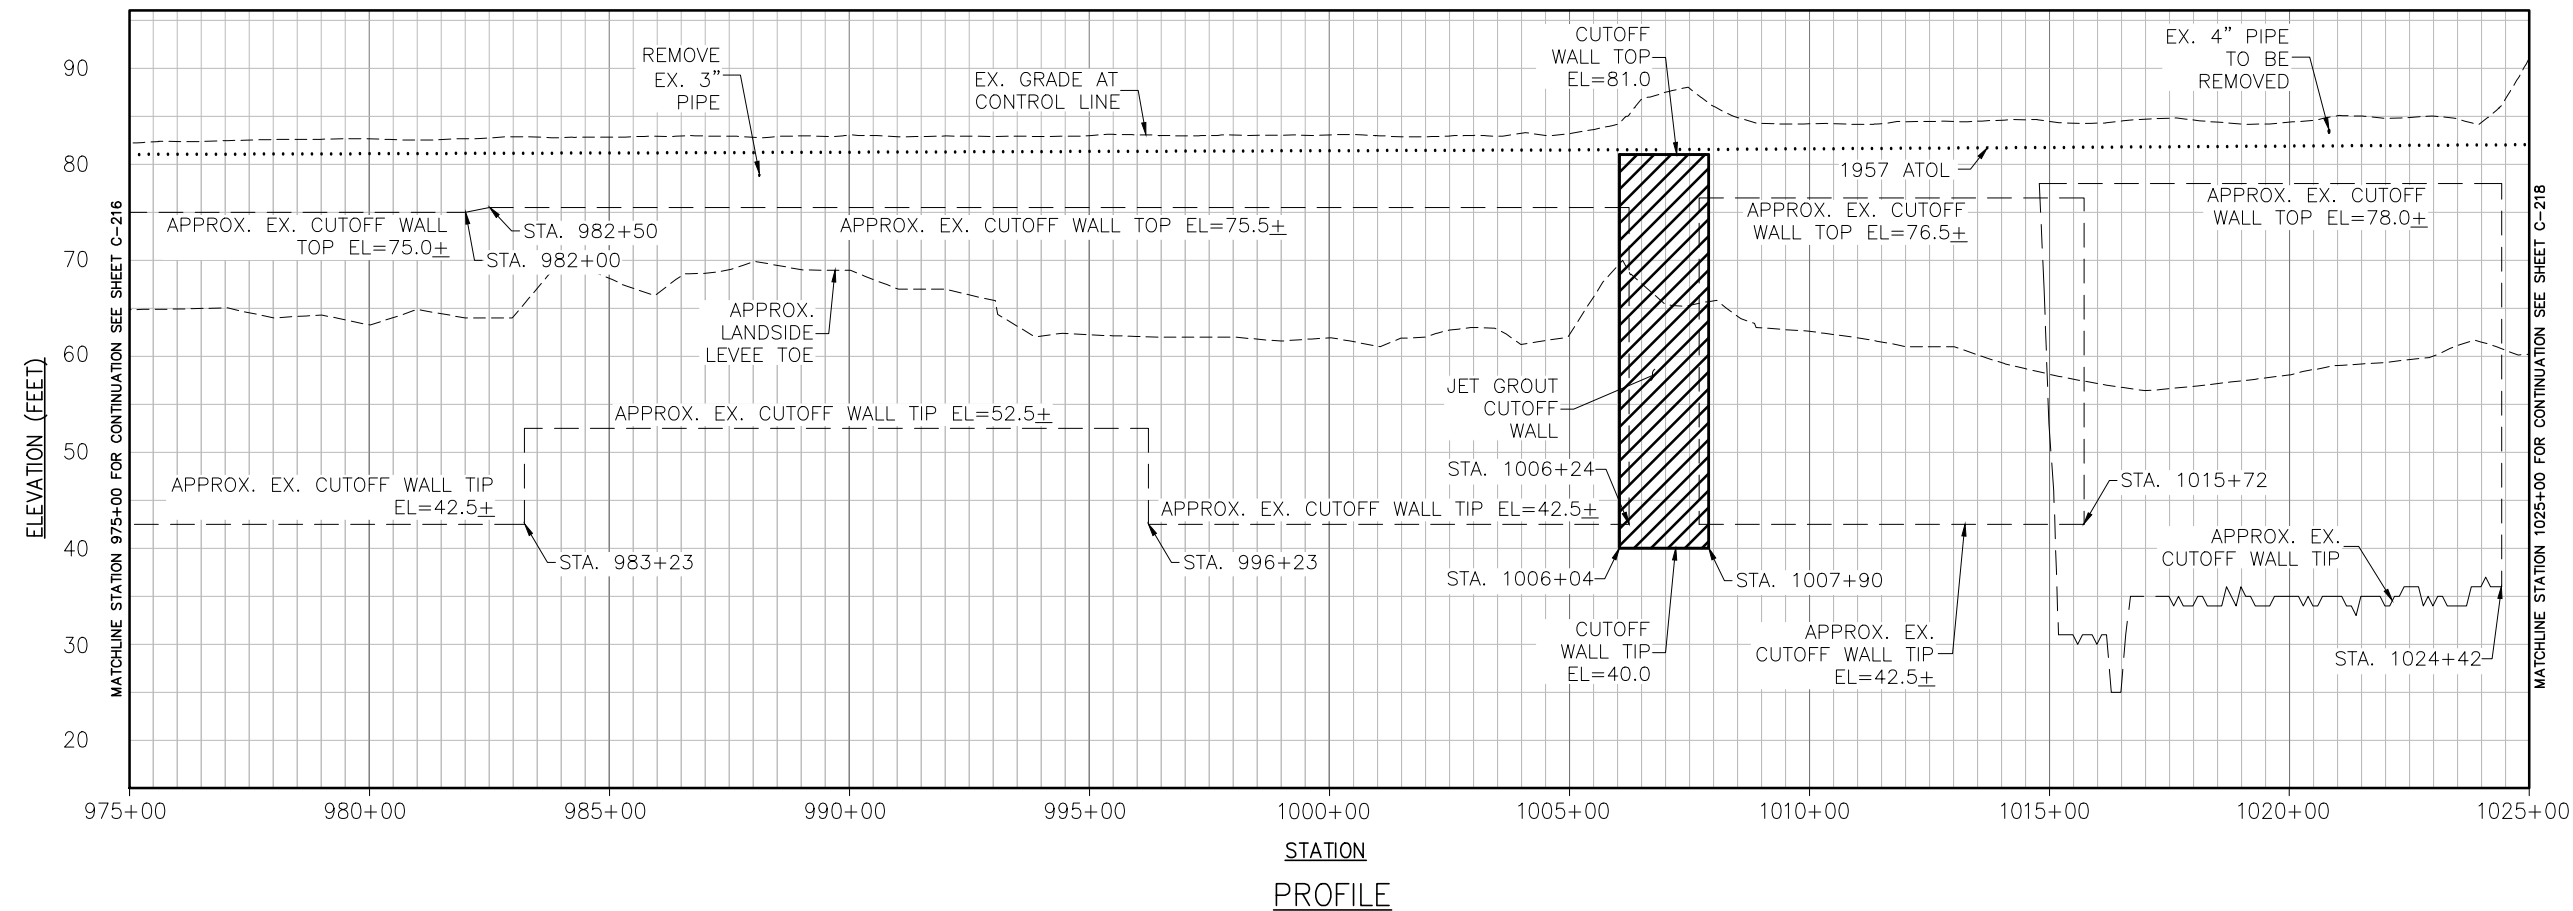VERTICAL DATUM

THE VERTICAL DATUM OF THIS SURVEY IS THE NORTH AMERICAN VERTICAL DATUM OF 1988 (NAVD88) BEING BASED ON NATIONAL GEODETIC SURVEY (NGS) POINTS LISTED AND DERIVED BY GLOBAL POSITIONING SYSTEM (GPS) STATIC METHOD.



**US Army Corps
of Engineers®**
Sacramento District

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DESIGNED BY DEPARTMENT OF THE ARMY CORPS OF ENGINEERS SACRAMENTO, CALIFORNIA	DATE _____	REV. _____
DRAWN BY _____	SPEC. NO. _____	DESIGN FILE NO. _____
REVIEWED BY _____	DRAWING CODE _____	
SUBMITTED BY _____	FILE NAME _____	
CHECKED BY CHIEF, CIV. ENGR. DES. SEC. A	PLOT SCALE _____	
SACRAMENTO DISTRICT IN-HOUSE DESIGN 1325 J STREET SACRAMENTO, CA 95814-2922		

SUTTER & BUTTE COUNTY CALIFORNIA
SUTTER BASIN PILOT FEASIBILITY STUDY
DRAFT REPORT
ALTERNATIVE SB-7 AND SB-8
PROFILE VIEW
STA 975+00 TO 1025+00

Sheet
reference
number:
C-217

PROFILE

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V: 1"=10'





NOT FOR CONSTRUCTION

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
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VERTICAL DATUM

THE VERTICAL DATUM OF THIS SURVEY IS THE NORTH AMERICAN VERTICAL DATUM OF 1988 (NAVD88) BEING BASED ON NATIONAL GEODETIC SURVEY (NGS) POINTS LISTED AND DERIVED BY GLOBAL POSITIONING SYSTEM (GPS) STATIC METHOD.

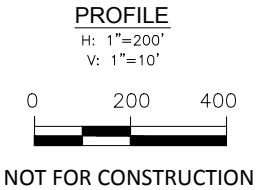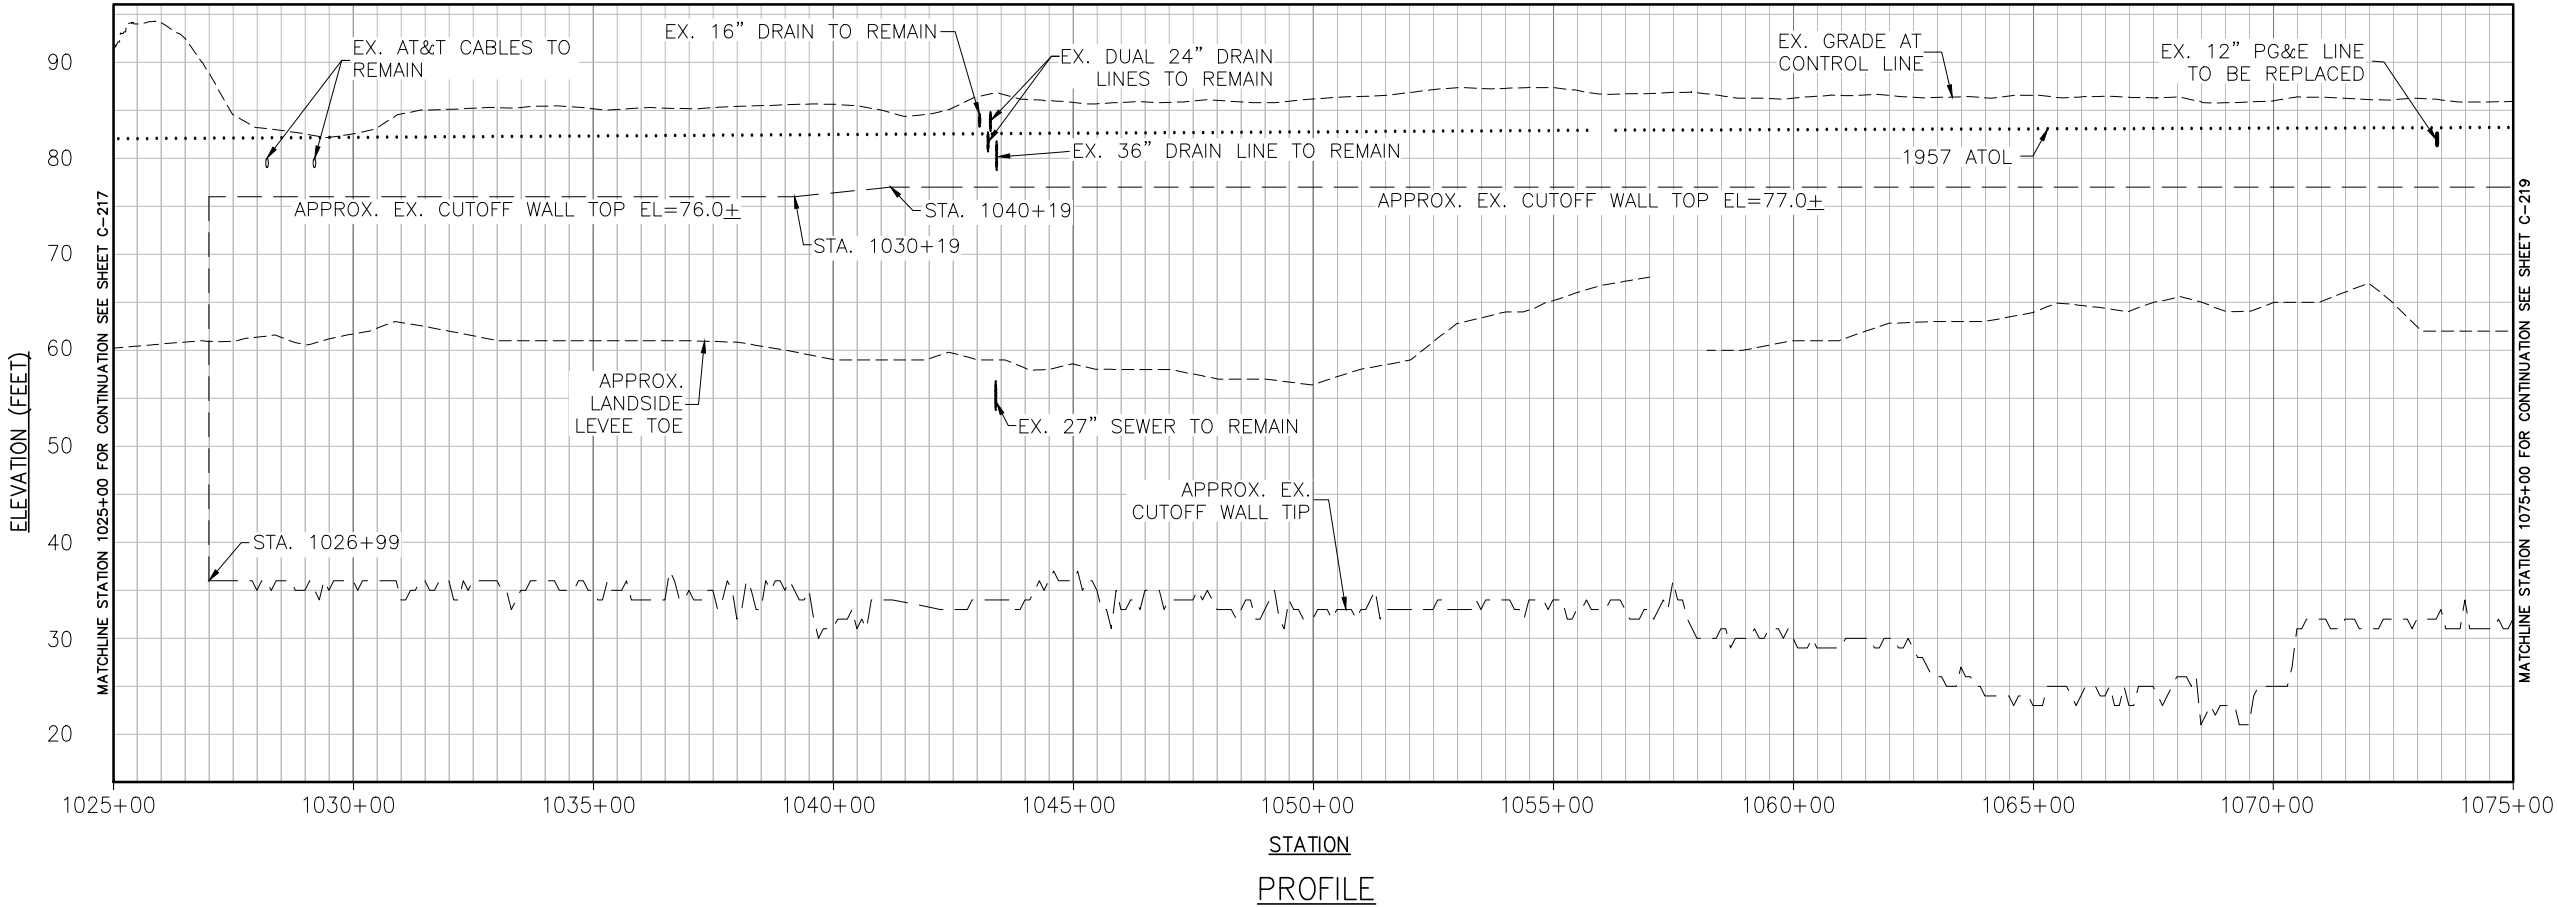

US Army Corps
of Engineers
Sacramento District

DATE	APPROVAL	DESCRIPTION	Rev.
		DESCRIPTION 8	
		DESCRIPTION 7	
		DESCRIPTION 6	
		DESCRIPTION 5	
		DESCRIPTION 4	
		DESCRIPTION 3	
		DESCRIPTION 2	
		DESCRIPTION 1	
		DESCRIPTION	

Designed by: _____

Dwn by: _____

Spec No.: _____

Reviewed by: _____

Drawing Code: _____

Submitted by: _____

File name: \$\$\$\$

Plot date: \$\$\$\$

Plot scale: \$\$\$\$

DEPARTMENT OF THE ARMY
CORPS OF ENGINEERS
SACRAMENTO, CALIFORNIA

SACRAMENTO DISTRICT
IN-HOUSE DESIGN
1325 J STREET
SACRAMENTO, CA 95814-2922

SUTTER & BUTTE COUNTY CALIFORNIA

SUTTER BASIN PILOT FEASIBILITY STUDY
DRAFT REPORT


ALTERNATIVE SB-7 AND SB-8

PROFILE VIEW

STA 1025+00 TO 1075+00

Sheet
reference
number:

C-218

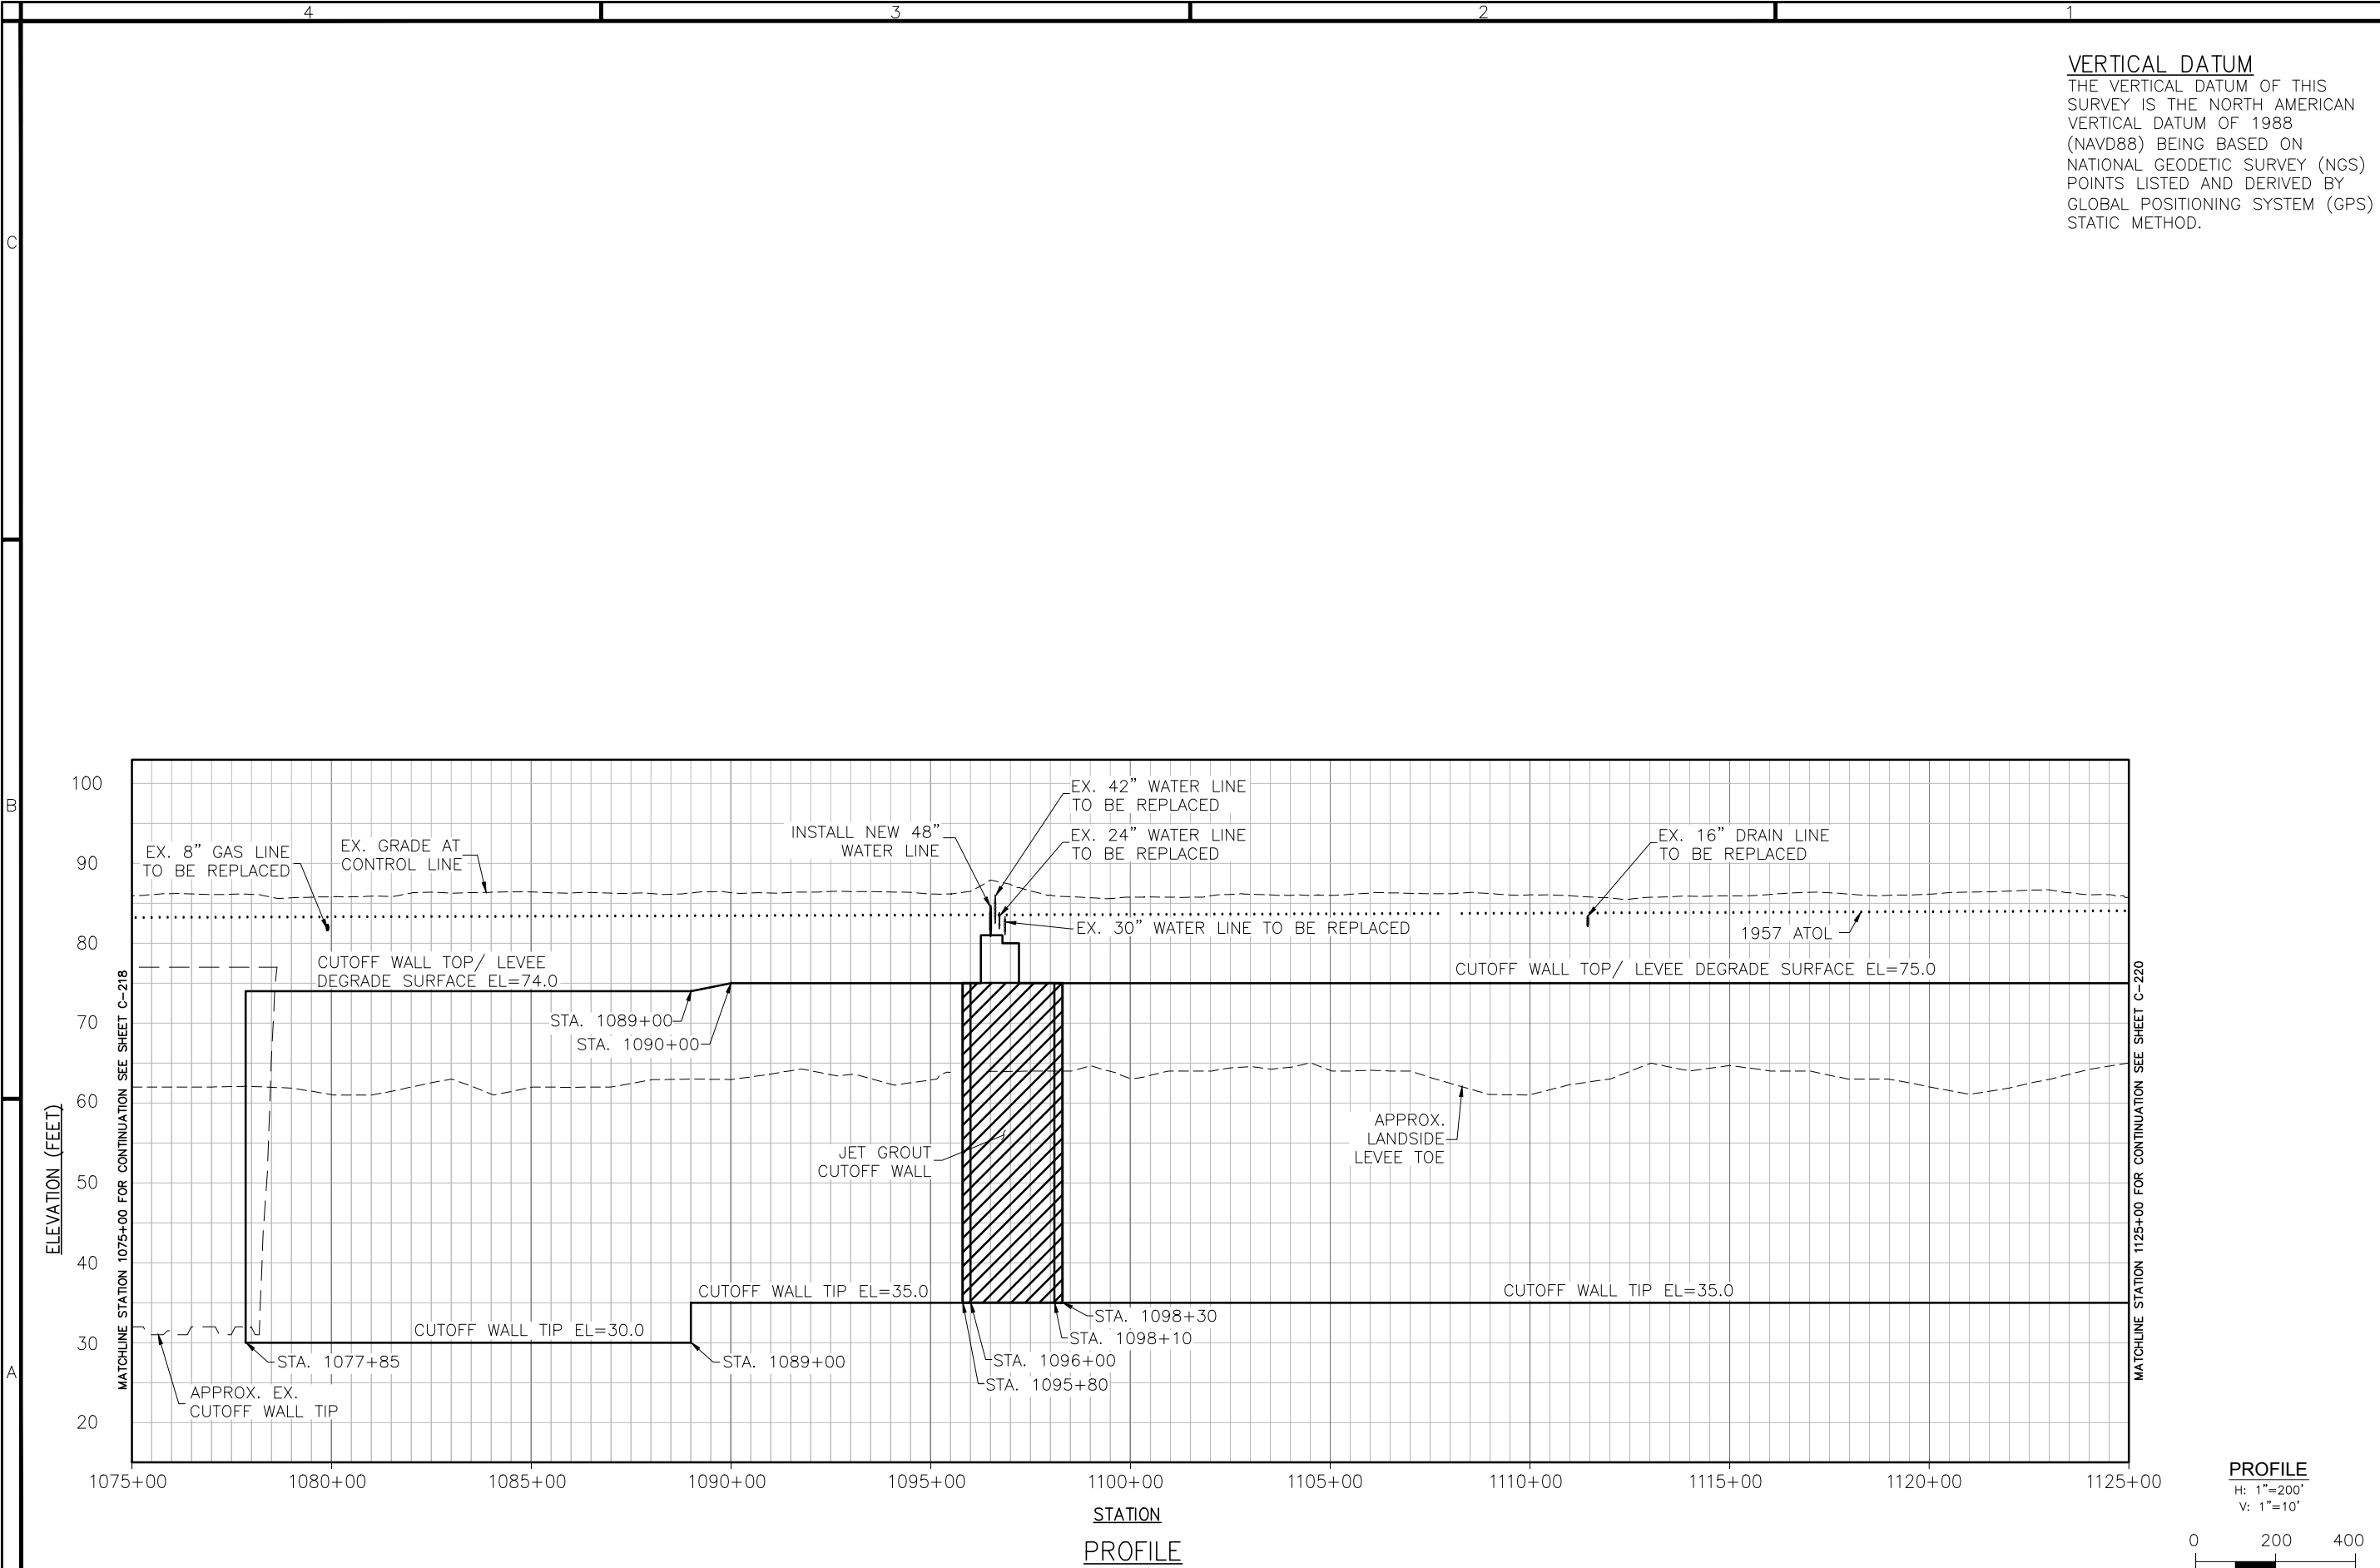

VERTICAL DATUM
THE VERTICAL DATUM OF THIS SURVEY IS THE NORTH AMERICAN VERTICAL DATUM OF 1988 (NAVD88) BEING BASED ON NATIONAL GEODETIC SURVEY (NGS) POINTS LISTED AND DERIVED BY GLOBAL POSITIONING SYSTEM (GPS) STATIC METHOD.

US Army Corps
of Engineers
Sacramento District

Rev.	Date:	Designed by:	Spec No.:	Design file no:	Rev.
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DEPARTMENT OF THE ARMY
CORPS OF ENGINEERS
SACRAMENTO, CALIFORNIA

SACRAMENTO DISTRICT
IN-HOUSE DESIGN
1325 J STREET
SACRAMENTO, CA 95814-2922

SUTTER & BUTTE COUNTY CALIFORNIA

SUTTER BASIN PILOT FEASIBILITY STUDY
DRAFT REPORT


ALTERNATIVE SB-7 AND SB-8
PROFILE VIEW
STA 1075+00 TO 1125+00

Sheet
reference
number:
C-219


PROFILE
H: 1"=200'
V: 1"=10'

0 200 400

NOT FOR CONSTRUCTION

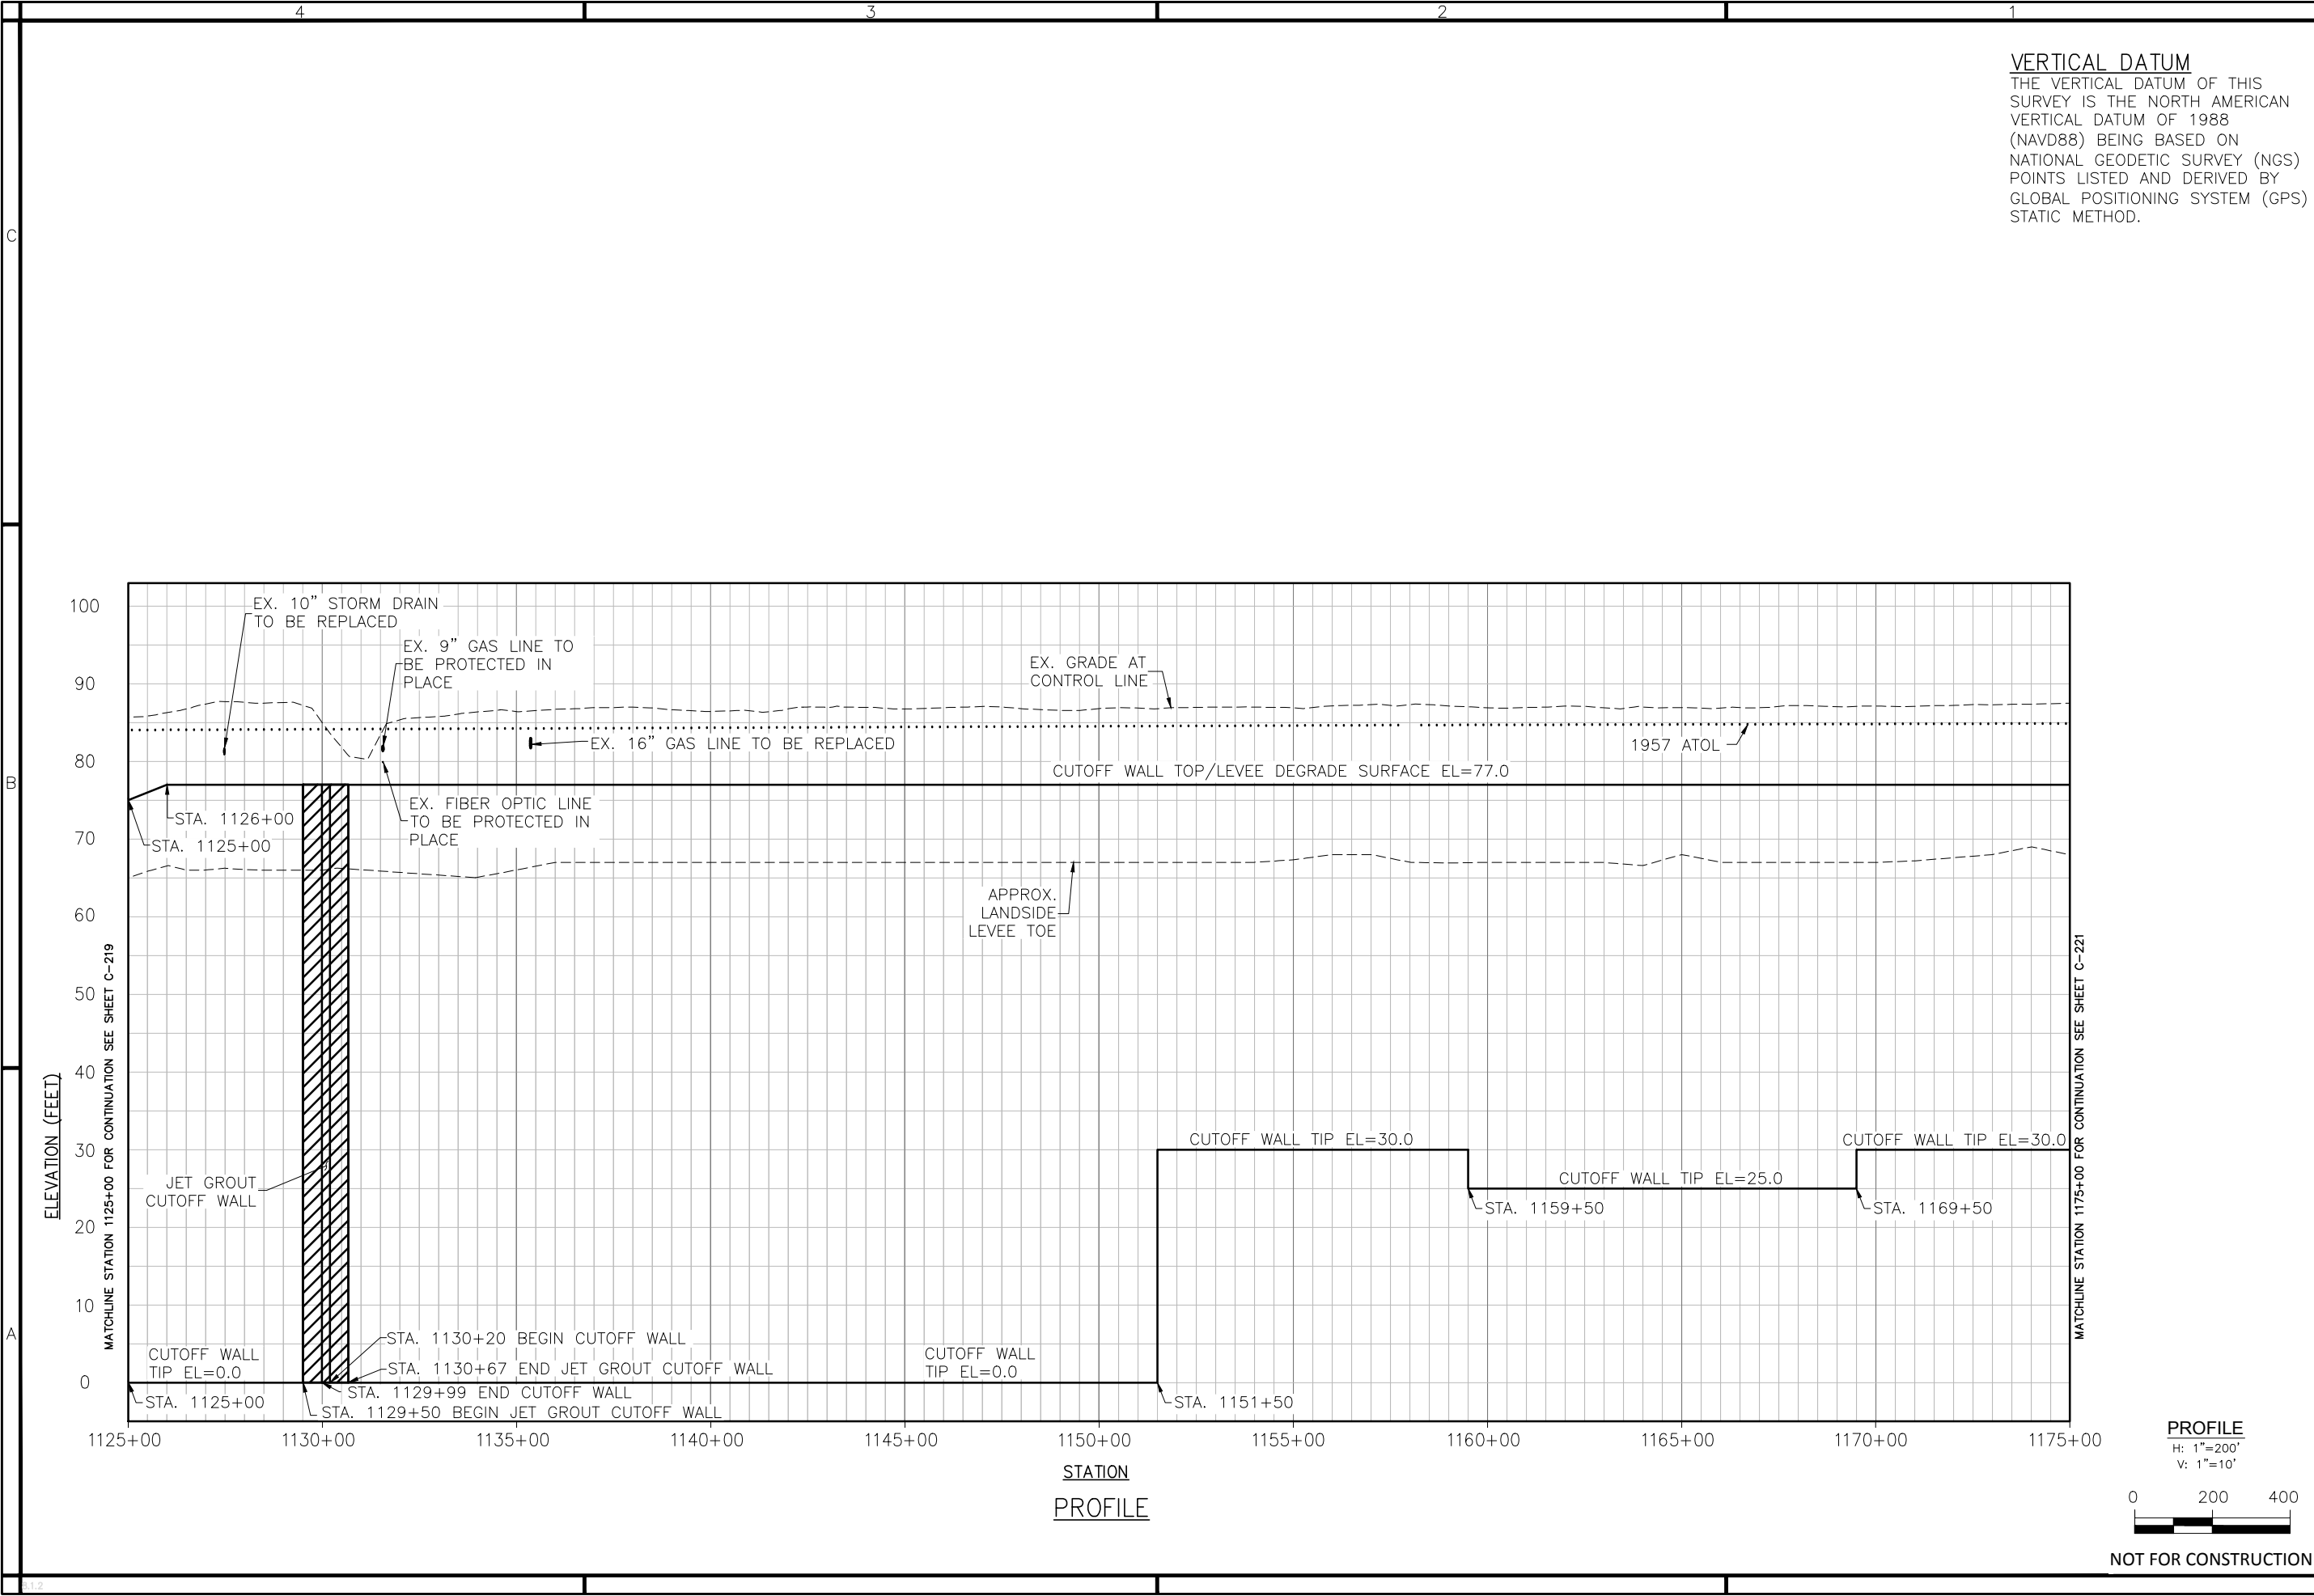

VERTICAL DATUM
THE VERTICAL DATUM OF THIS SURVEY IS THE NORTH AMERICAN VERTICAL DATUM OF 1988 (NAVD88) BEING BASED ON NATIONAL GEODETIC SURVEY (NGS) POINTS LISTED AND DERIVED BY GLOBAL POSITIONING SYSTEM (GPS) STATIC METHOD.



US Army Corps
of Engineers
Sacramento District

DATE	APPROVAL	DESCRIPTION	Rev.
	DATE7 APPROVAL	DESCRIPTION7	
	DATE6 APPROVAL	DESCRIPTION6	
	DATE5 APPROVAL	DESCRIPTION5	
	DATE4 APPROVAL	DESCRIPTION4	
	DATE3 APPROVAL	DESCRIPTION3	
	DATE2 APPROVAL	DESCRIPTION2	
	DATE1 APPROVAL	DESCRIPTION1	

Designed by: _____ Date: _____

Dwn by: _____ Spec No.: _____

Reviewed by: _____ Design file no: _____

Submitted by: _____ Drawing Code: _____

Chief, CIV ENR SES SEC A

File name: **\$\$\$State\$\$\$**

Plot date: _____ Plot scale: _____

DEPARTMENT OF THE ARMY
CORPS OF ENGINEERS
SACRAMENTO, CALIFORNIA

SACRAMENTO DISTRICT
IN-HOUSE DESIGN
1325 J STREET
SACRAMENTO, CA 95814-2922


SUTTER & BUTTE COUNTY CALIFORNIA

SUTTER BASIN PILOT FEASIBILITY STUDY
DRAFT REPORT


ALTERNATIVE SB-7 AND SB-8
PROFILE VIEW
STA 1125+00 TO 1175+00

Sheet
reference
number:

C-220

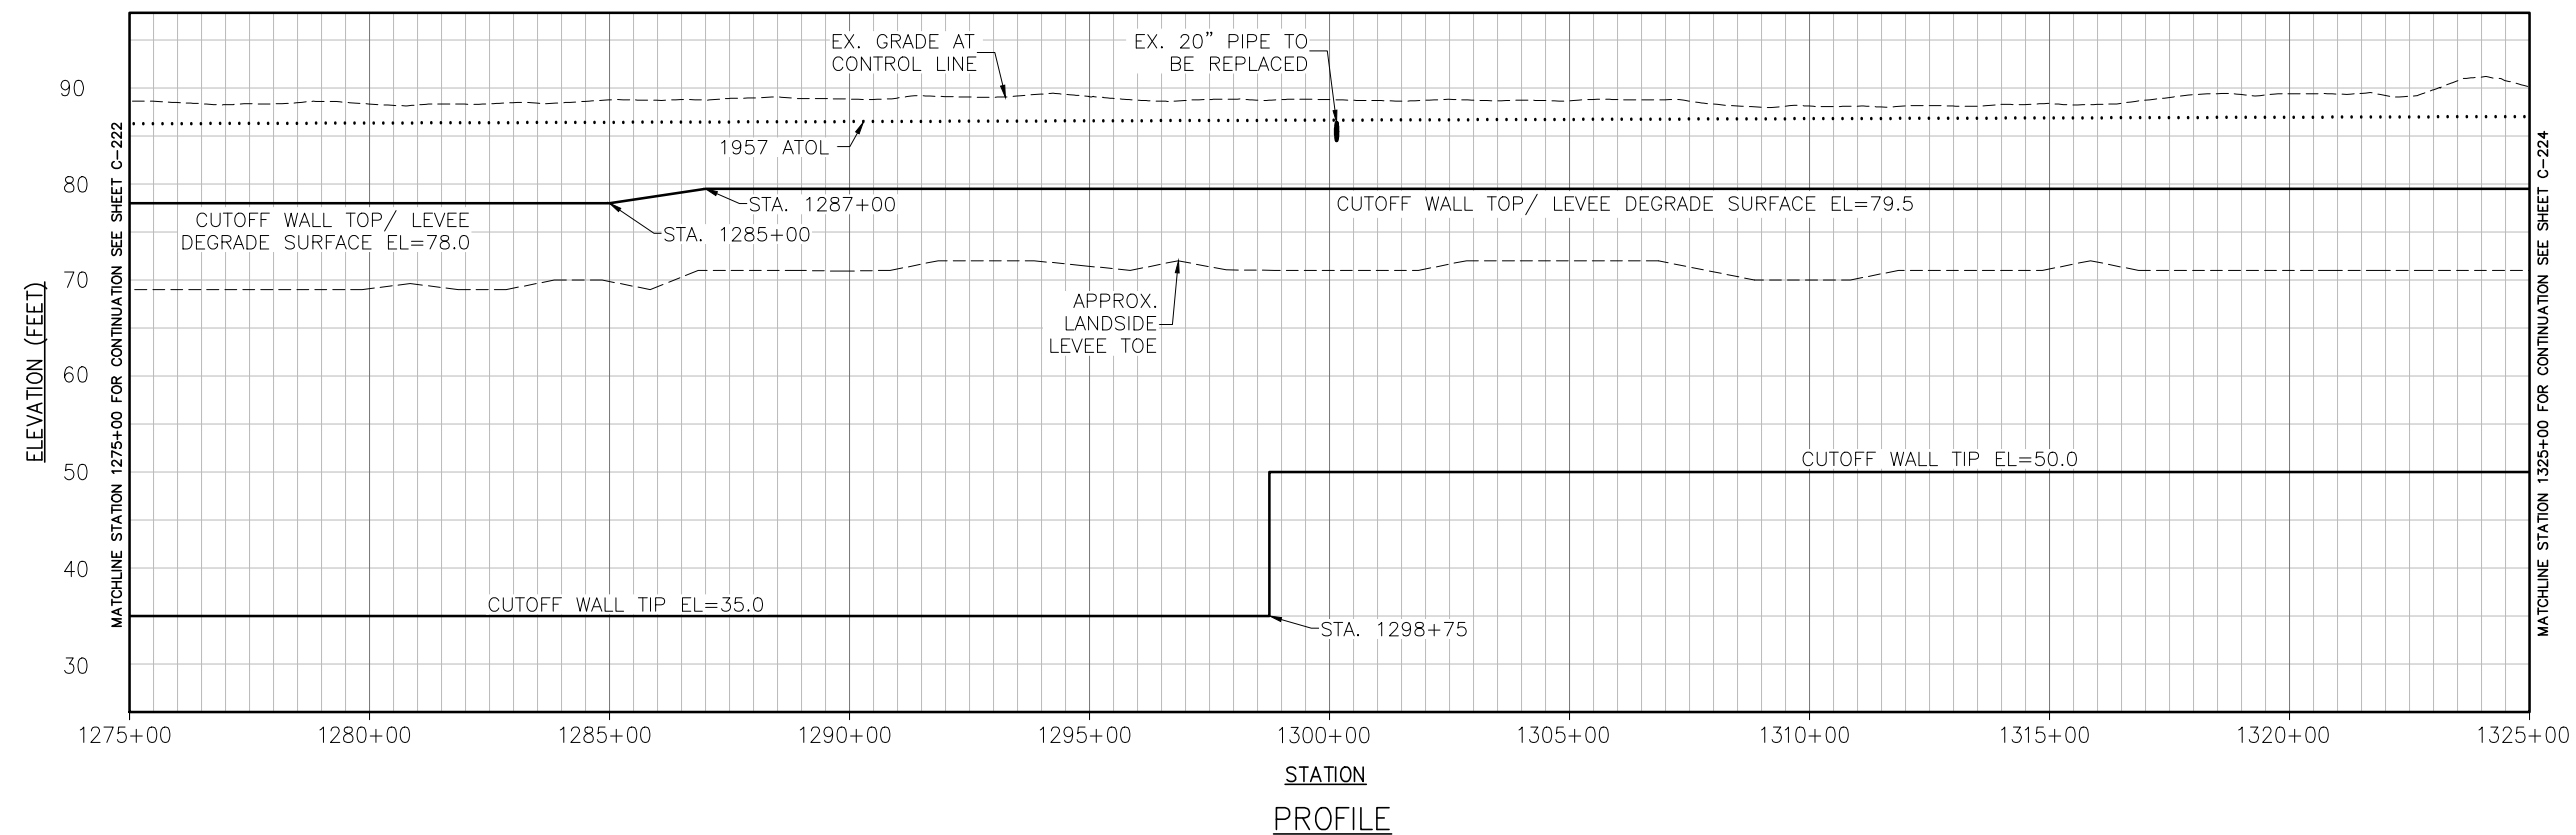


NOT FOR CONSTRUCTION

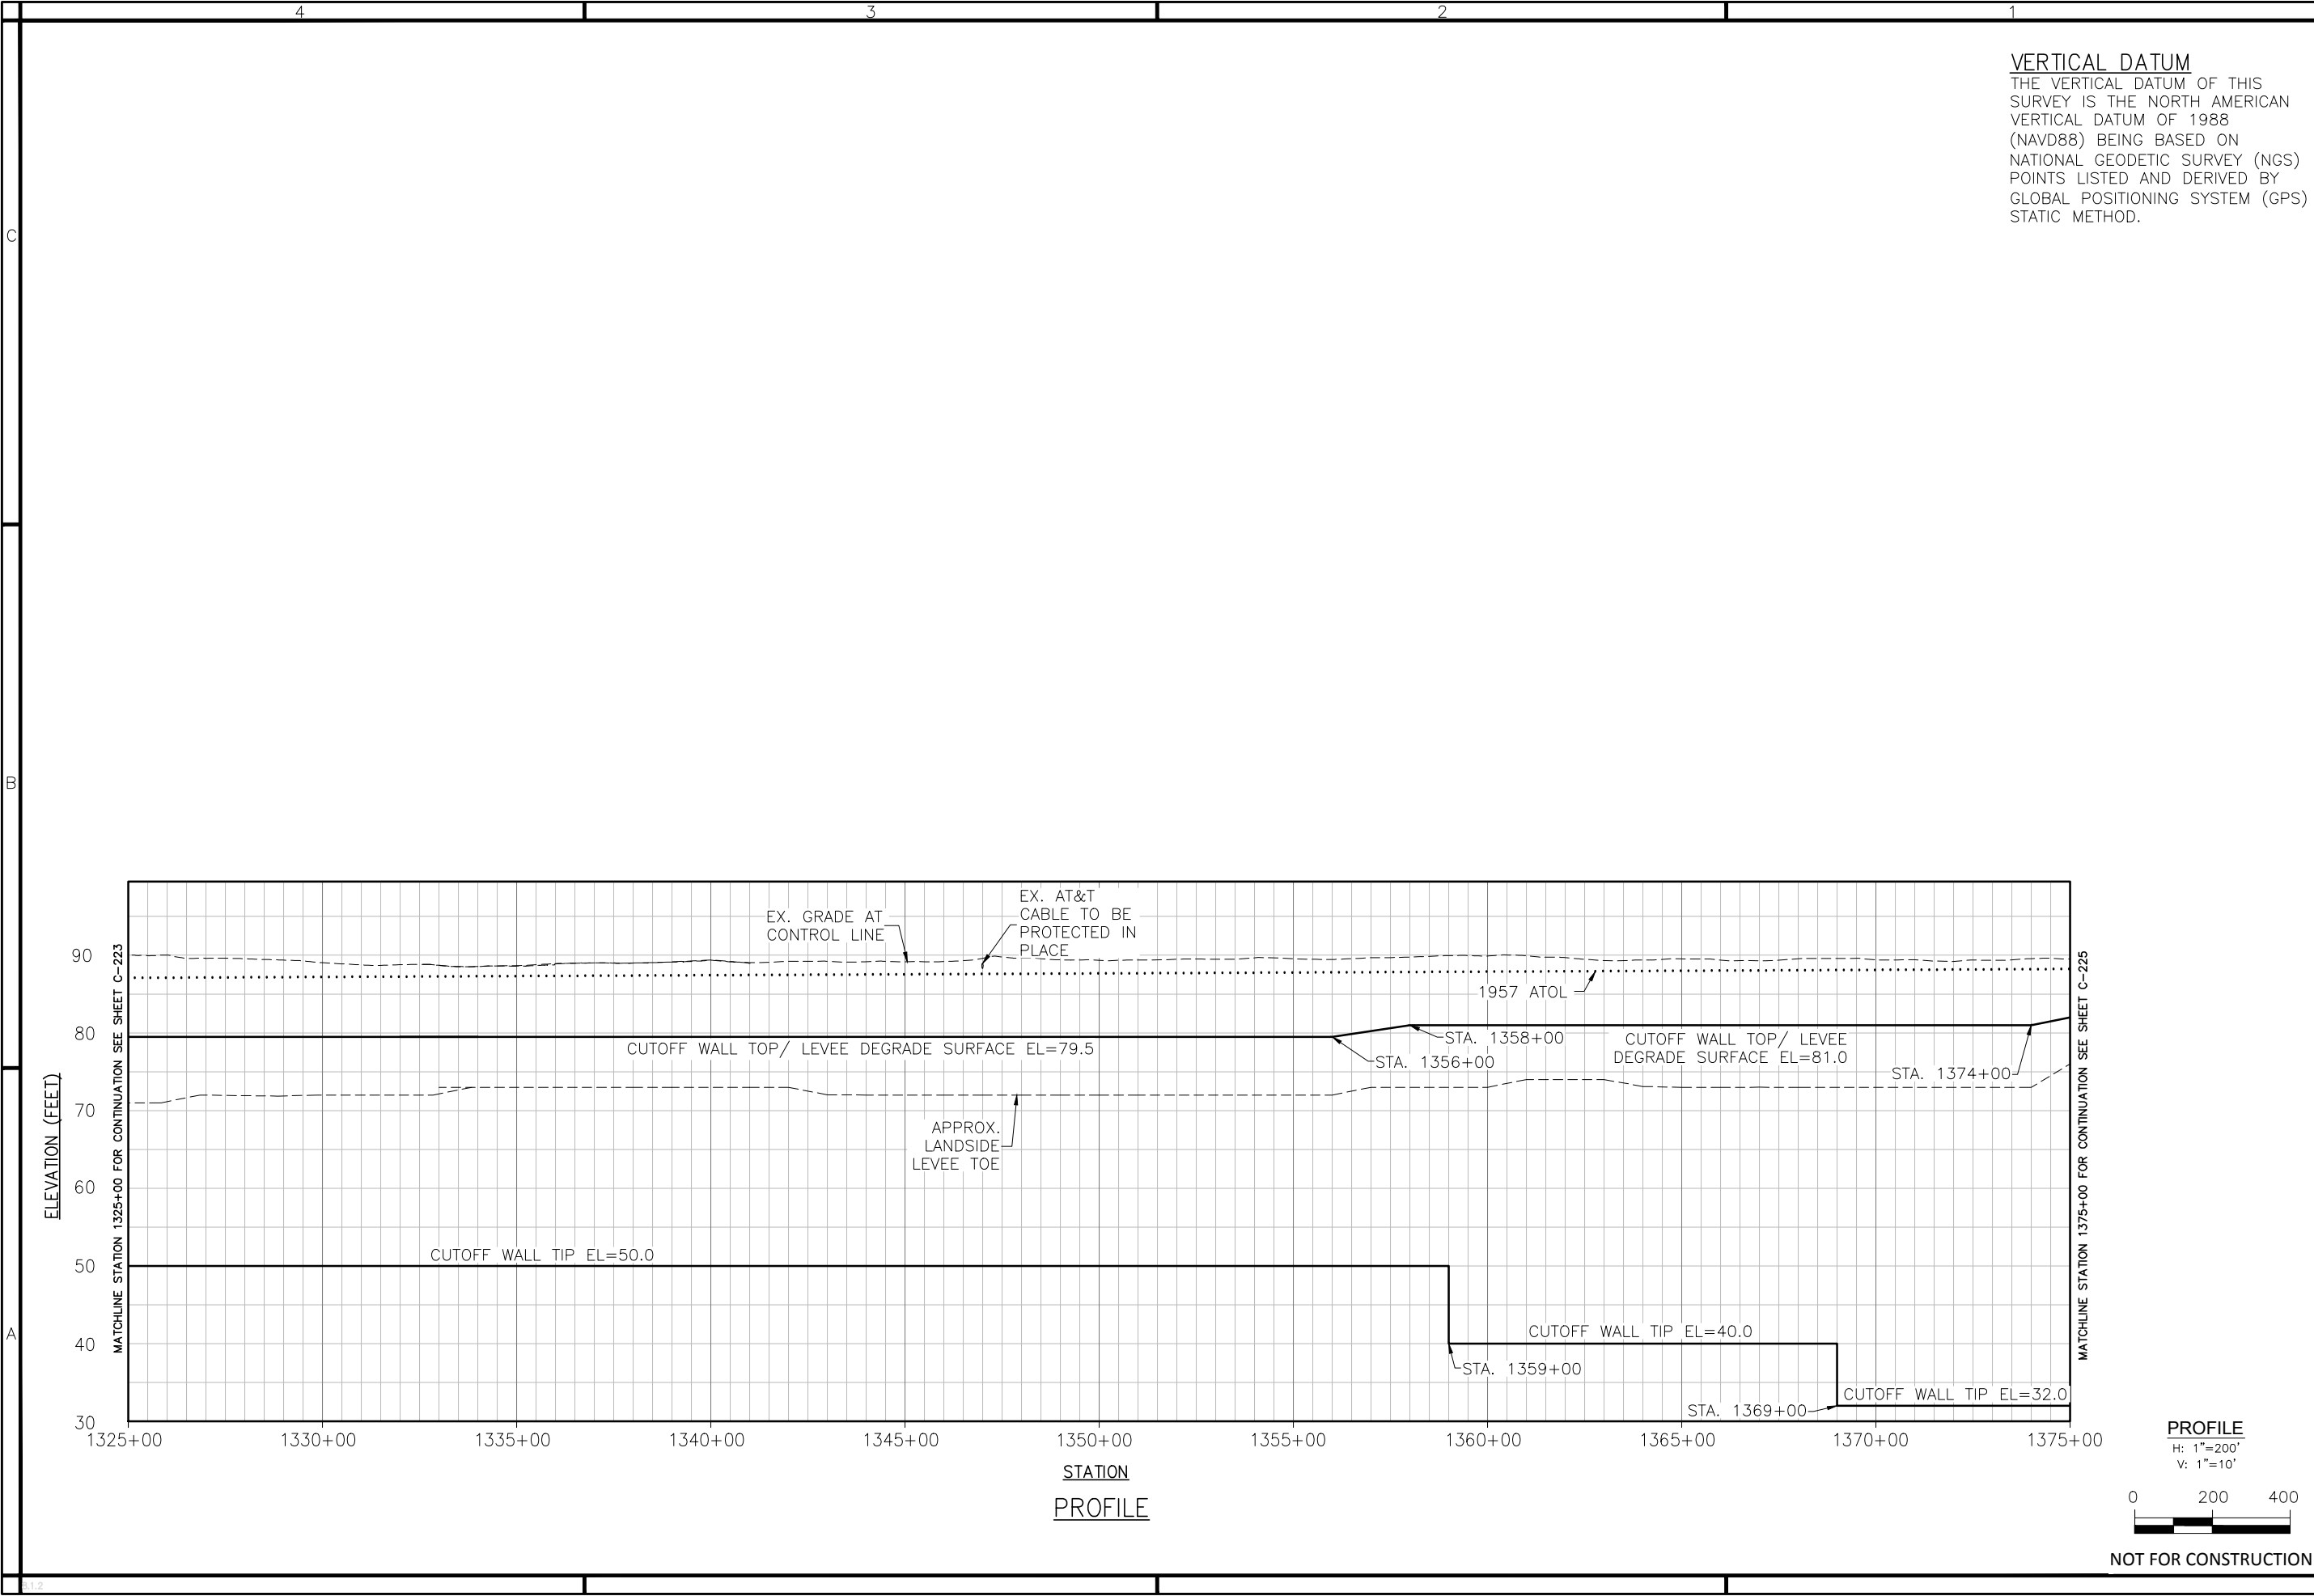

VERTICAL DATUM

THE VERTICAL DATUM OF THIS SURVEY IS THE NORTH AMERICAN VERTICAL DATUM OF 1988 (NAVD88) BEING BASED ON NATIONAL GEODETIC SURVEY (NGS) POINTS LISTED AND DERIVED BY GLOBAL POSITIONING SYSTEM (GPS) STATIC METHOD.



US Army Corps
of Engineers
Sacramento District

DATE APPROVED	DESCRIPTION	Rev.
DATE APPROVED	DESCRIPTION 8	Rev.
DATE APPROVED	DESCRIPTION 7	Rev.
DATE APPROVED	DESCRIPTION 6	Rev.
DATE APPROVED	DESCRIPTION 5	Rev.
DATE APPROVED	DESCRIPTION 4	Rev.
DATE APPROVED	DESCRIPTION 3	Rev.
DATE APPROVED	DESCRIPTION 2	Rev.
DATE APPROVED	DESCRIPTION 1	Rev.
DATE APPROVED	DESCRIPTION	Rev.

DESIGNED BY: _____

DRAWN BY: _____

REVIEWED BY: _____

SUBMITTED BY: _____

FILE NAME: _____

PLOT DATE: _____

PLOT SCALE: _____

DEPARTMENT OF THE ARMY
CORPS OF ENGINEERS
SACRAMENTO, CALIFORNIA

SACRAMENTO DISTRICT
IN-HOUSE DESIGN
1325 J STREET
SACRAMENTO, CA 95814-2922


SUTTER & BUTTE COUNTY CALIFORNIA


SUTTER BASIN PILOT FEASIBILITY STUDY
DRAFT REPORT

ALTERNATIVE SB-7 AND SB-8
PROFILE VIEW
STA 1325+00 TO 1375+00

Sheet
reference
number:

C-224

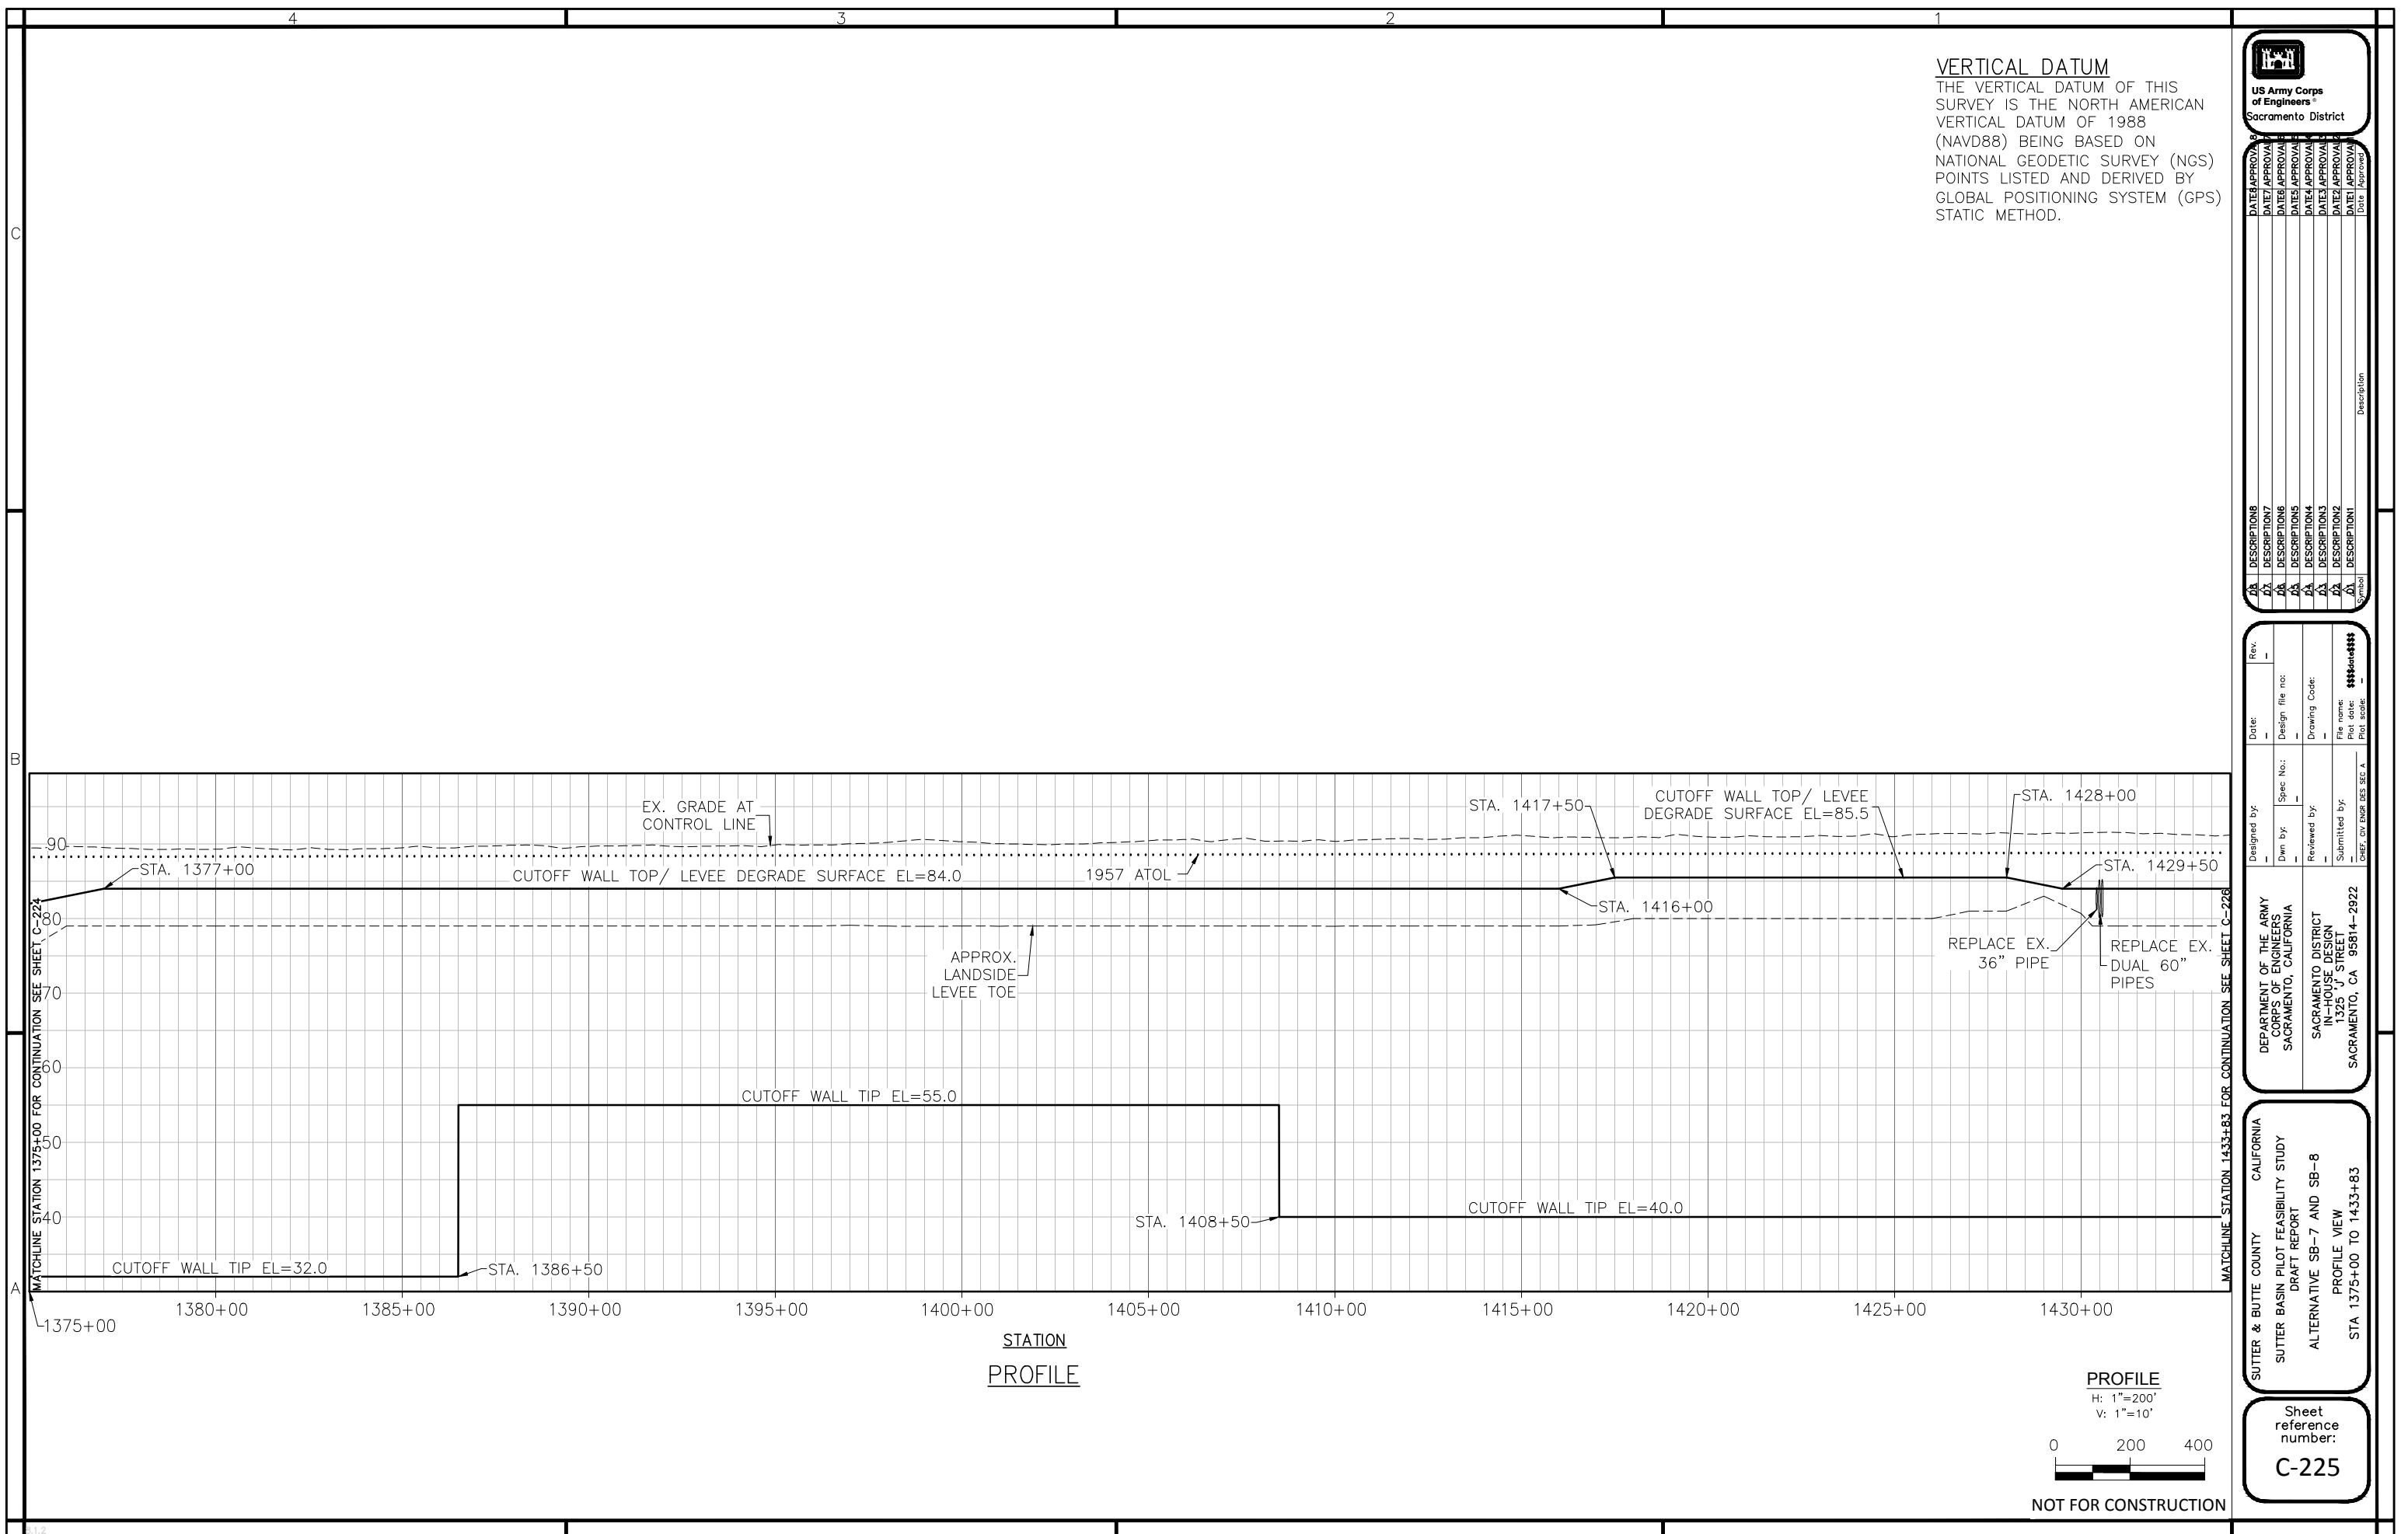

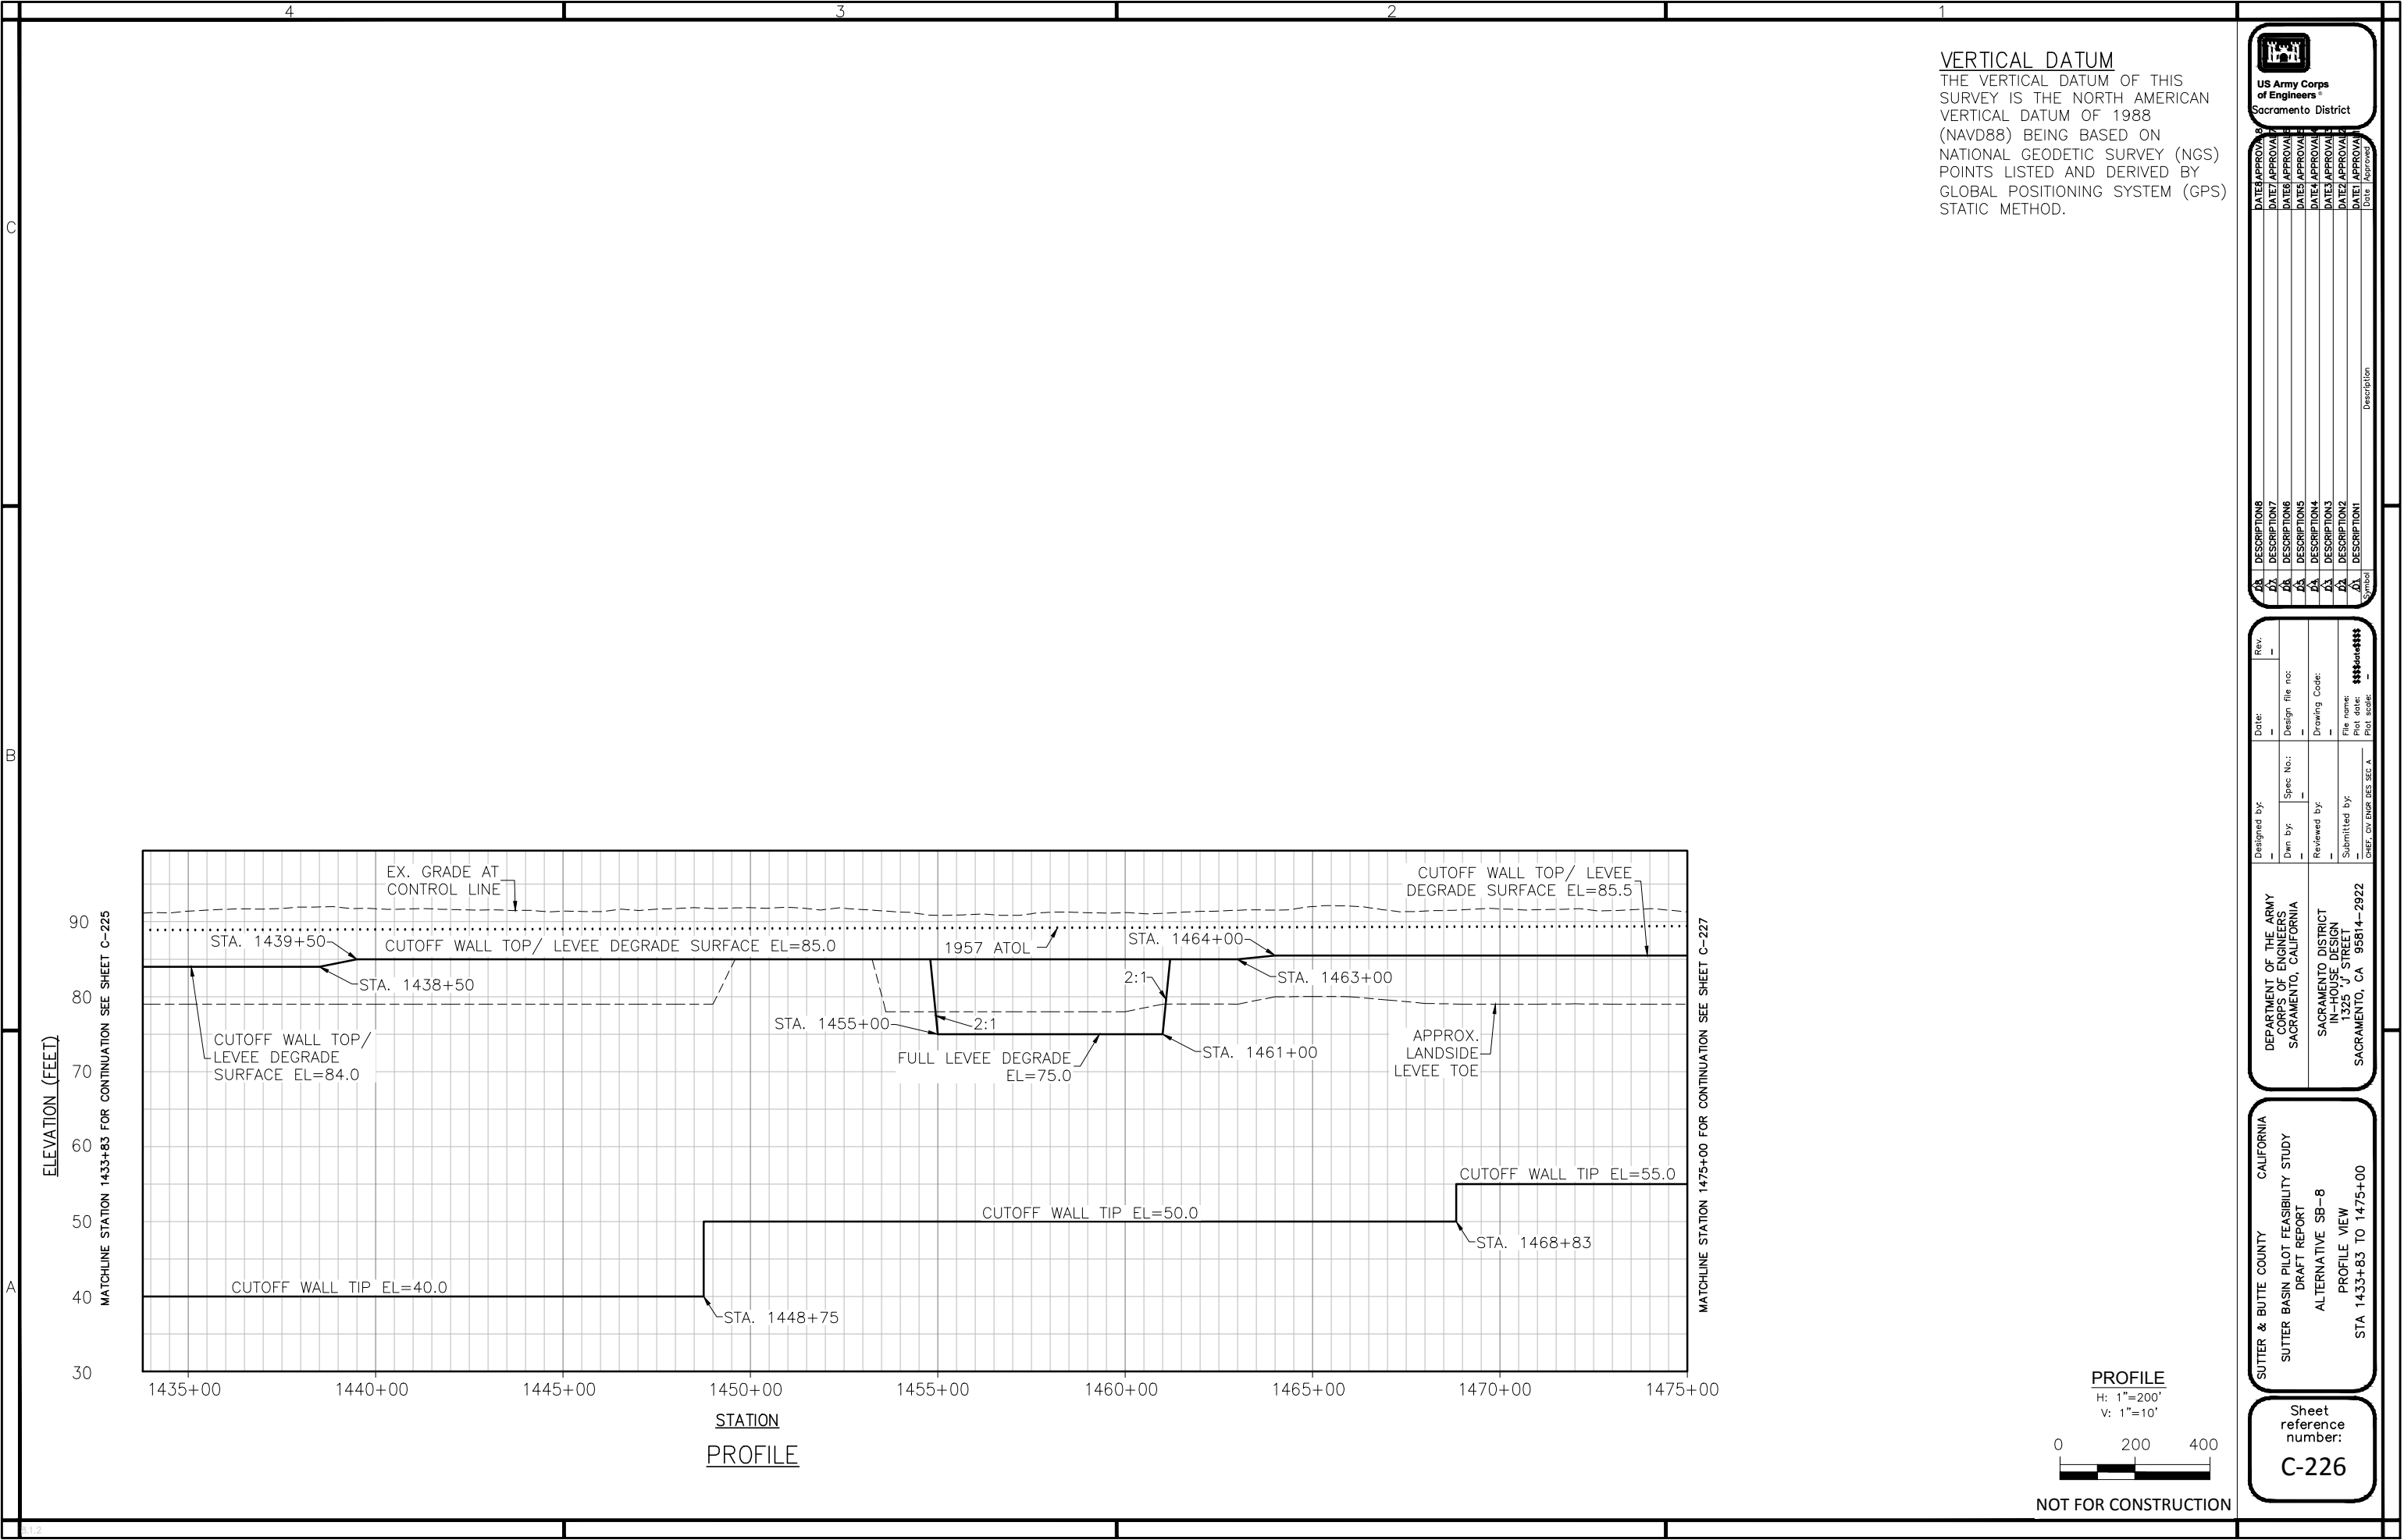

EX. GRADE AT CONTROL LINE

STA. 1439+50

STA. 1438+50

CUTOFF WALL TOP/ LEVEE DEGRADE SURFACE EL=84.0

CUTOFF WALL TOP/ LEVEE DEGRADE SURFACE EL=85.0

1957 ATOL

STA. 1455+00

2:1

FULL LEVEE DEGRADE EL=75.0

2:1

STA. 1461+00

STA. 1463+00

STA. 1464+00

CUTOFF WALL TOP/ LEVEE DEGRADE SURFACE EL=85.5

APPROX. LANDSIDE LEVEE TOE

CUTOFF WALL TIP EL=50.0

STA. 1468+83

CUTOFF WALL TIP EL=55.0

STA. 1448+75

CUTOFF WALL TIP EL=40.0

STATION


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
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200

400

NOT FOR CONSTRUCTION



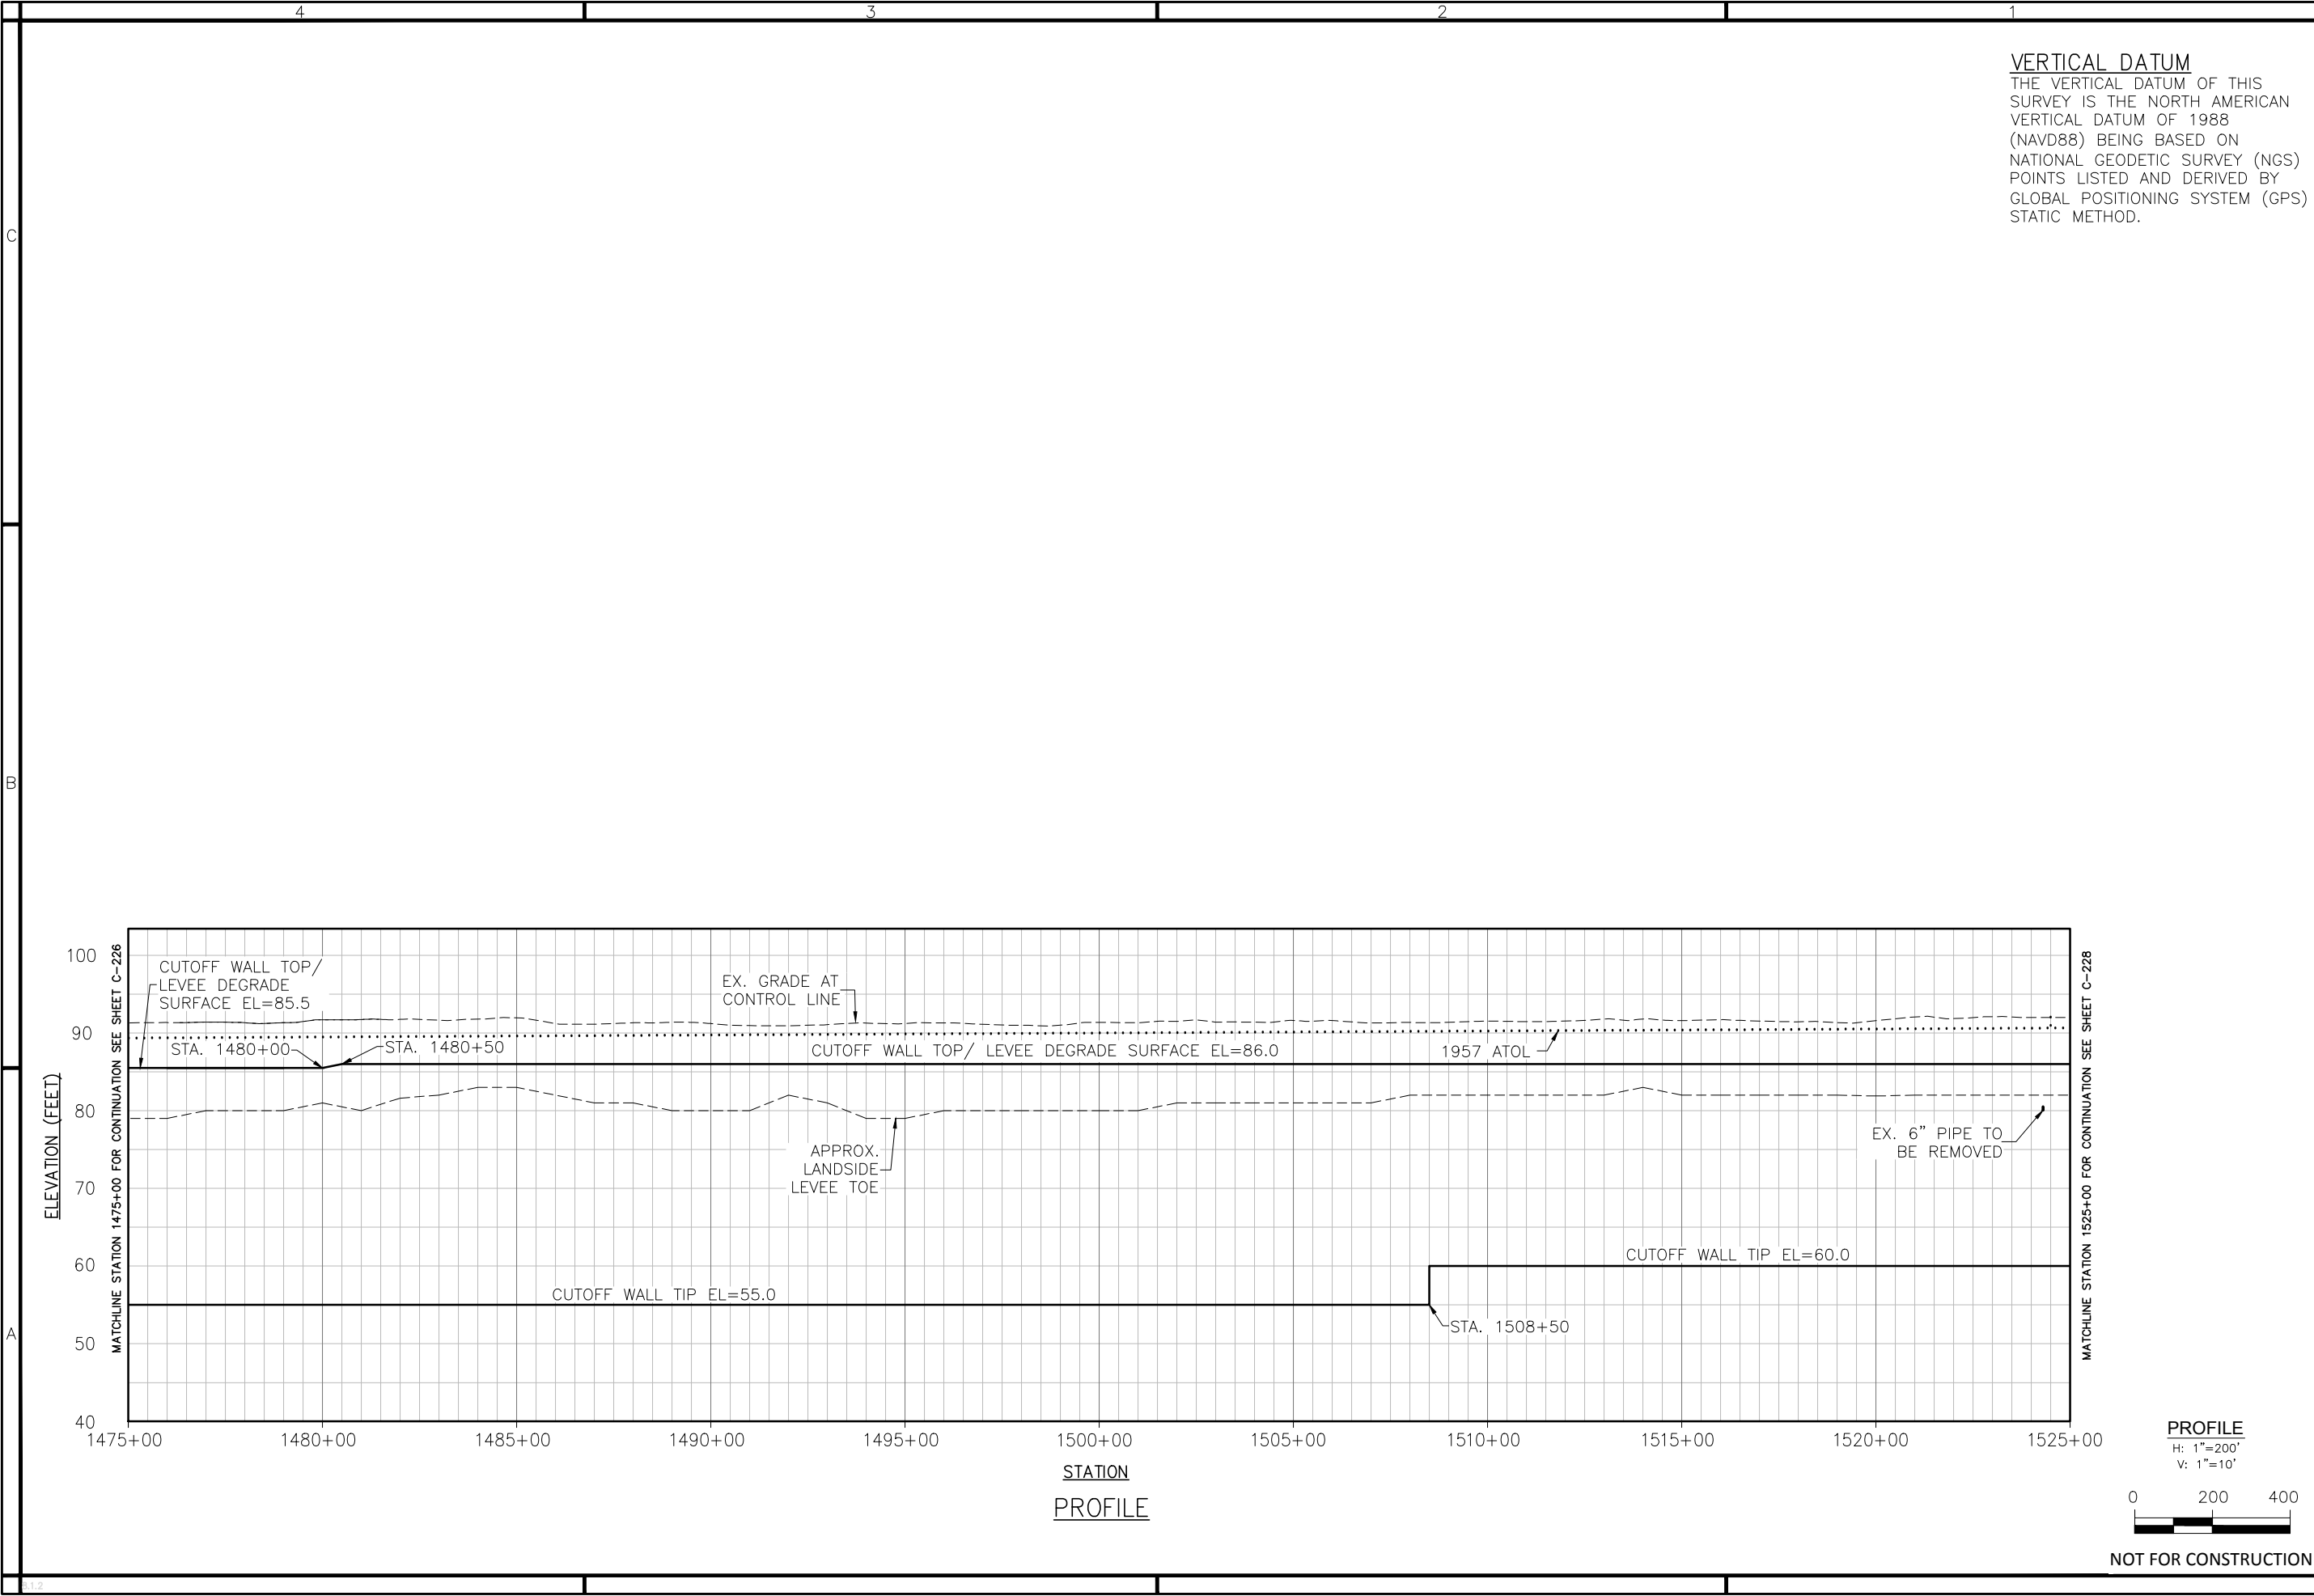

US Army Corps
of Engineers
Sacramento District

DATE APPROVED	DESCRIPTION	Rev.
DATE APPROVED	DESCRIPTION 8	Rev.
DATE APPROVED	DESCRIPTION 7	Rev.
DATE APPROVED	DESCRIPTION 6	Rev.
DATE APPROVED	DESCRIPTION 5	Rev.
DATE APPROVED	DESCRIPTION 4	Rev.
DATE APPROVED	DESCRIPTION 3	Rev.
DATE APPROVED	DESCRIPTION 2	Rev.
DATE APPROVED	DESCRIPTION 1	Rev.
DATE APPROVED	DESCRIPTION	Rev.

Designed by	Date	Rev.
Designed by	Date	Rev.
Dwn by	Design file no:	
Reviewed by	Drawing Code:	
Submitted by	File name:	\$\$\$Mat-\$\$\$
Chief, CIV ENR SES SEC A	Plot date:	Plot scale:

DEPARTMENT OF THE ARMY
CORPS OF ENGINEERS
SACRAMENTO, CALIFORNIA

SACRAMENTO DISTRICT
IN-HOUSE DESIGN
1325 J STREET
SACRAMENTO, CA 95814-2922

SUTTER & BUTTE COUNTY CALIFORNIA


SUTTER BASIN PILOT FEASIBILITY STUDY
DRAFT REPORT

ALTERNATIVE SB-8

PROFILE VIEW
STA 1475+00 TO 1525+00

Sheet
reference
number:


C-227

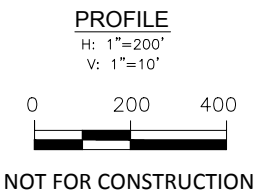


C

B

A

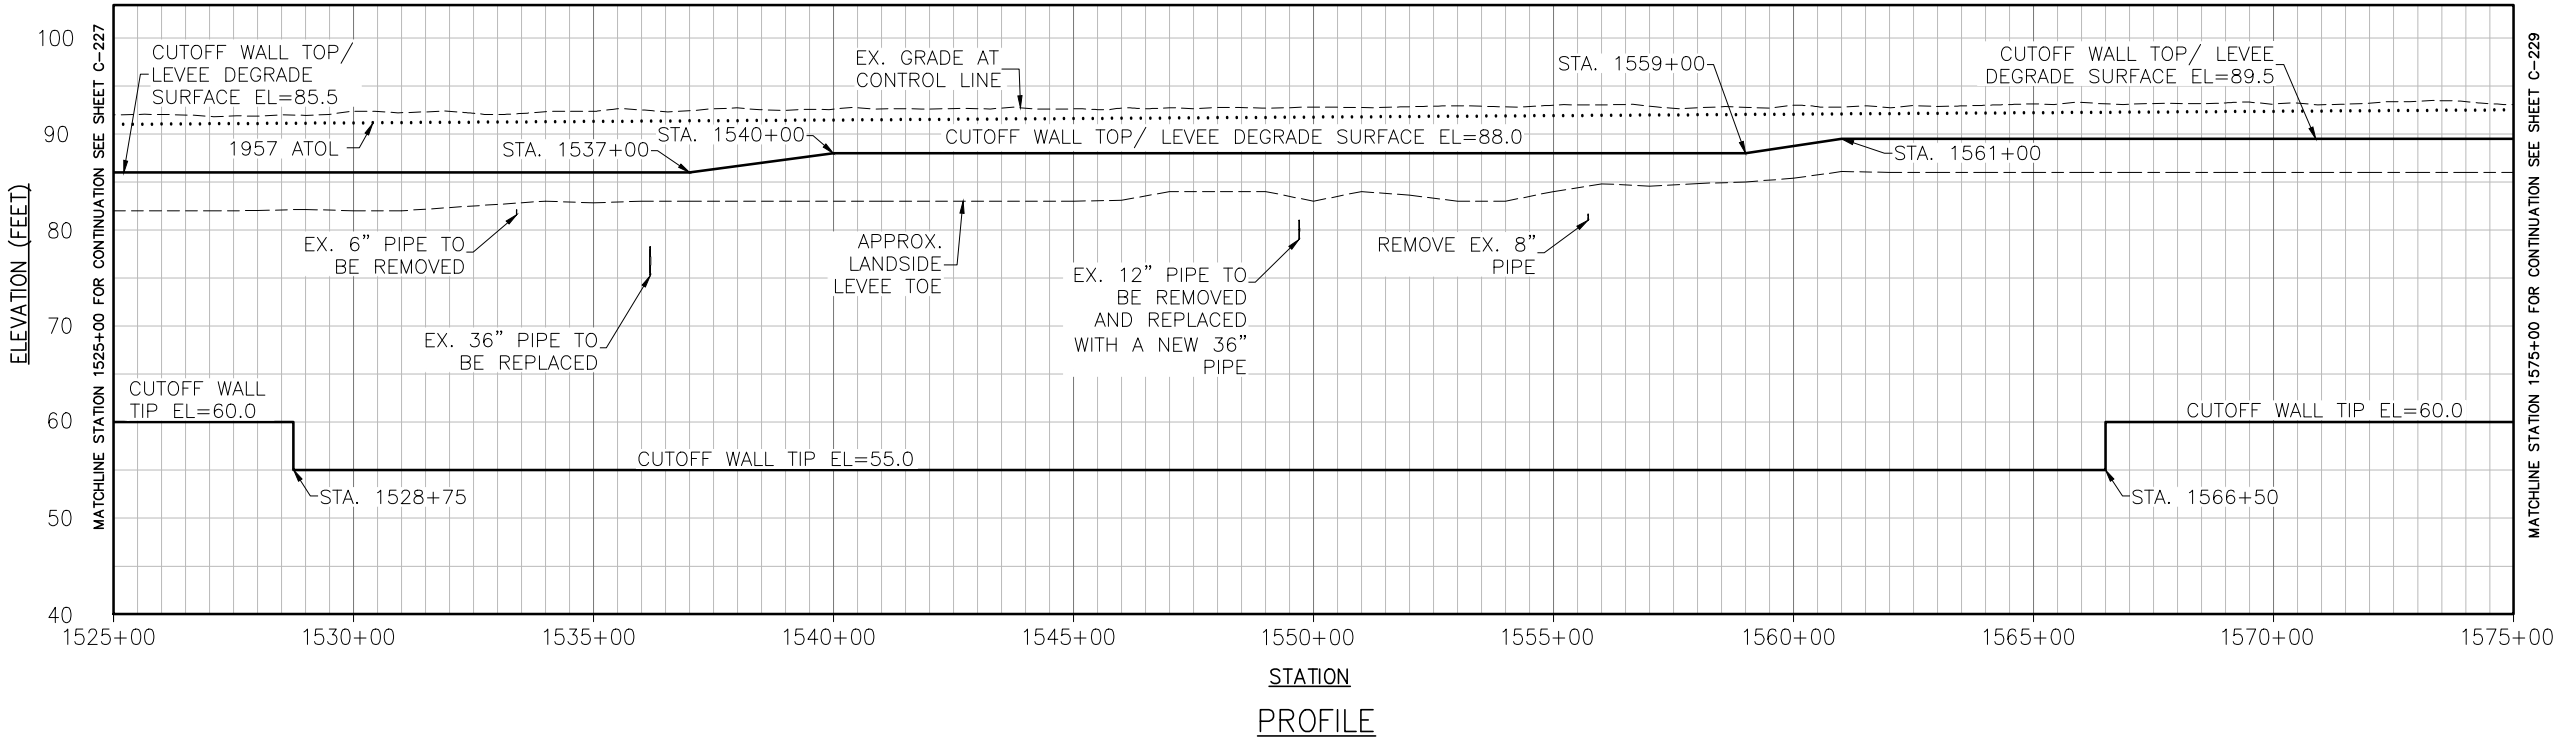

VERTICAL DATUM
THE VERTICAL DATUM OF THIS SURVEY IS THE NORTH AMERICAN VERTICAL DATUM OF 1988 (NAVD88) BEING BASED ON NATIONAL GEODETIC SURVEY (NGS) POINTS LISTED AND DERIVED BY GLOBAL POSITIONING SYSTEM (GPS) STATIC METHOD.



US Army Corps
of Engineers
Sacramento District

DATE	APPROVAL	DESCRIPTION
	DATE7 APPROVAL	DESCRIPTION7
	DATE6 APPROVAL	DESCRIPTION6
	DATE5 APPROVAL	DESCRIPTION5
	DATE4 APPROVAL	DESCRIPTION4
	DATE3 APPROVAL	DESCRIPTION3
	DATE2 APPROVAL	DESCRIPTION2
	DATE1 APPROVAL	DESCRIPTION1
	DATE	DESCRIPTION

Designed by: _____

Spec No.: _____

Dwn by: _____

Reviewed by: _____

Submitted by: _____

Chief, CIV ENR SES SEC A

Date: _____

Design file no: _____

Drawing Code: _____

File name: **\$\$\$Mat-\$\$\$**

Plot date: _____

Plot scale: _____


DEPARTMENT OF THE ARMY
CORPS OF ENGINEERS
SACRAMENTO, CALIFORNIA


SACRAMENTO DISTRICT
IN-HOUSE DESIGN
1325 J STREET
SACRAMENTO, CA 95814-2922

SUTTER & BUTTE COUNTY CALIFORNIA


SUTTER BASIN PILOT FEASIBILITY STUDY
DRAFT REPORT
ALTERNATIVE SB-8
PROFILE VIEW
STA 1525+00 TO 1575+00

Sheet
reference
number:
C-228

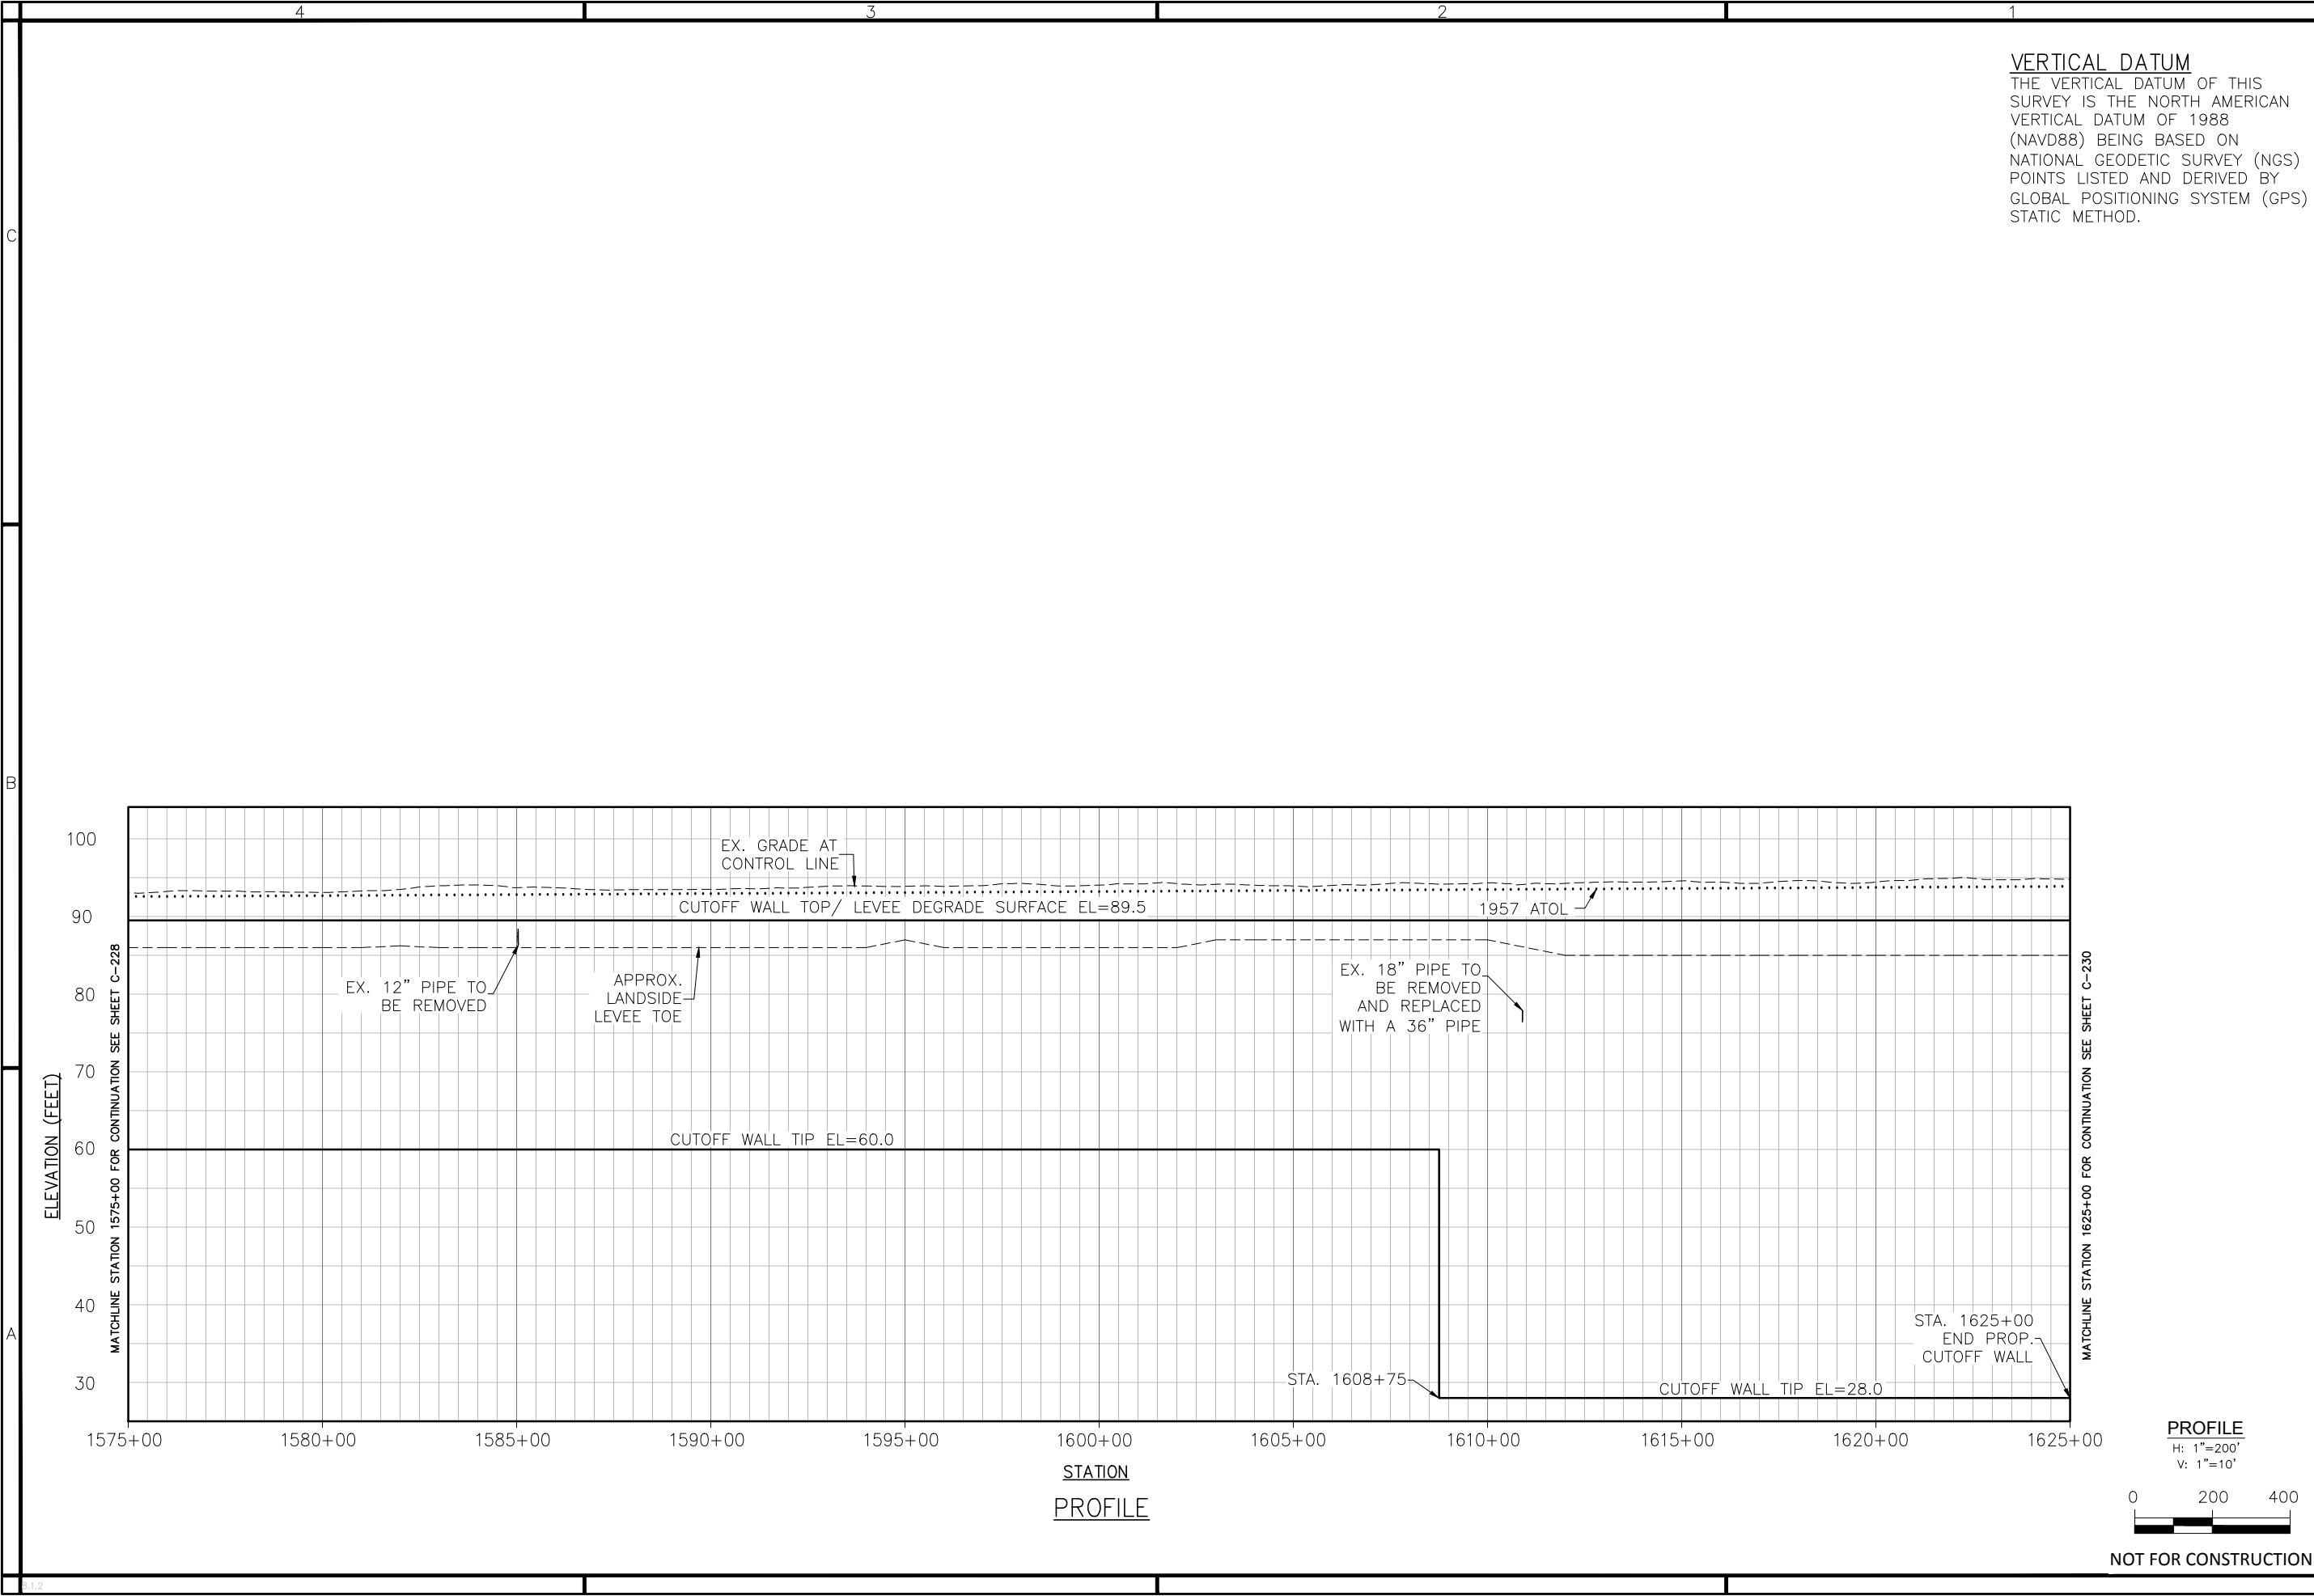

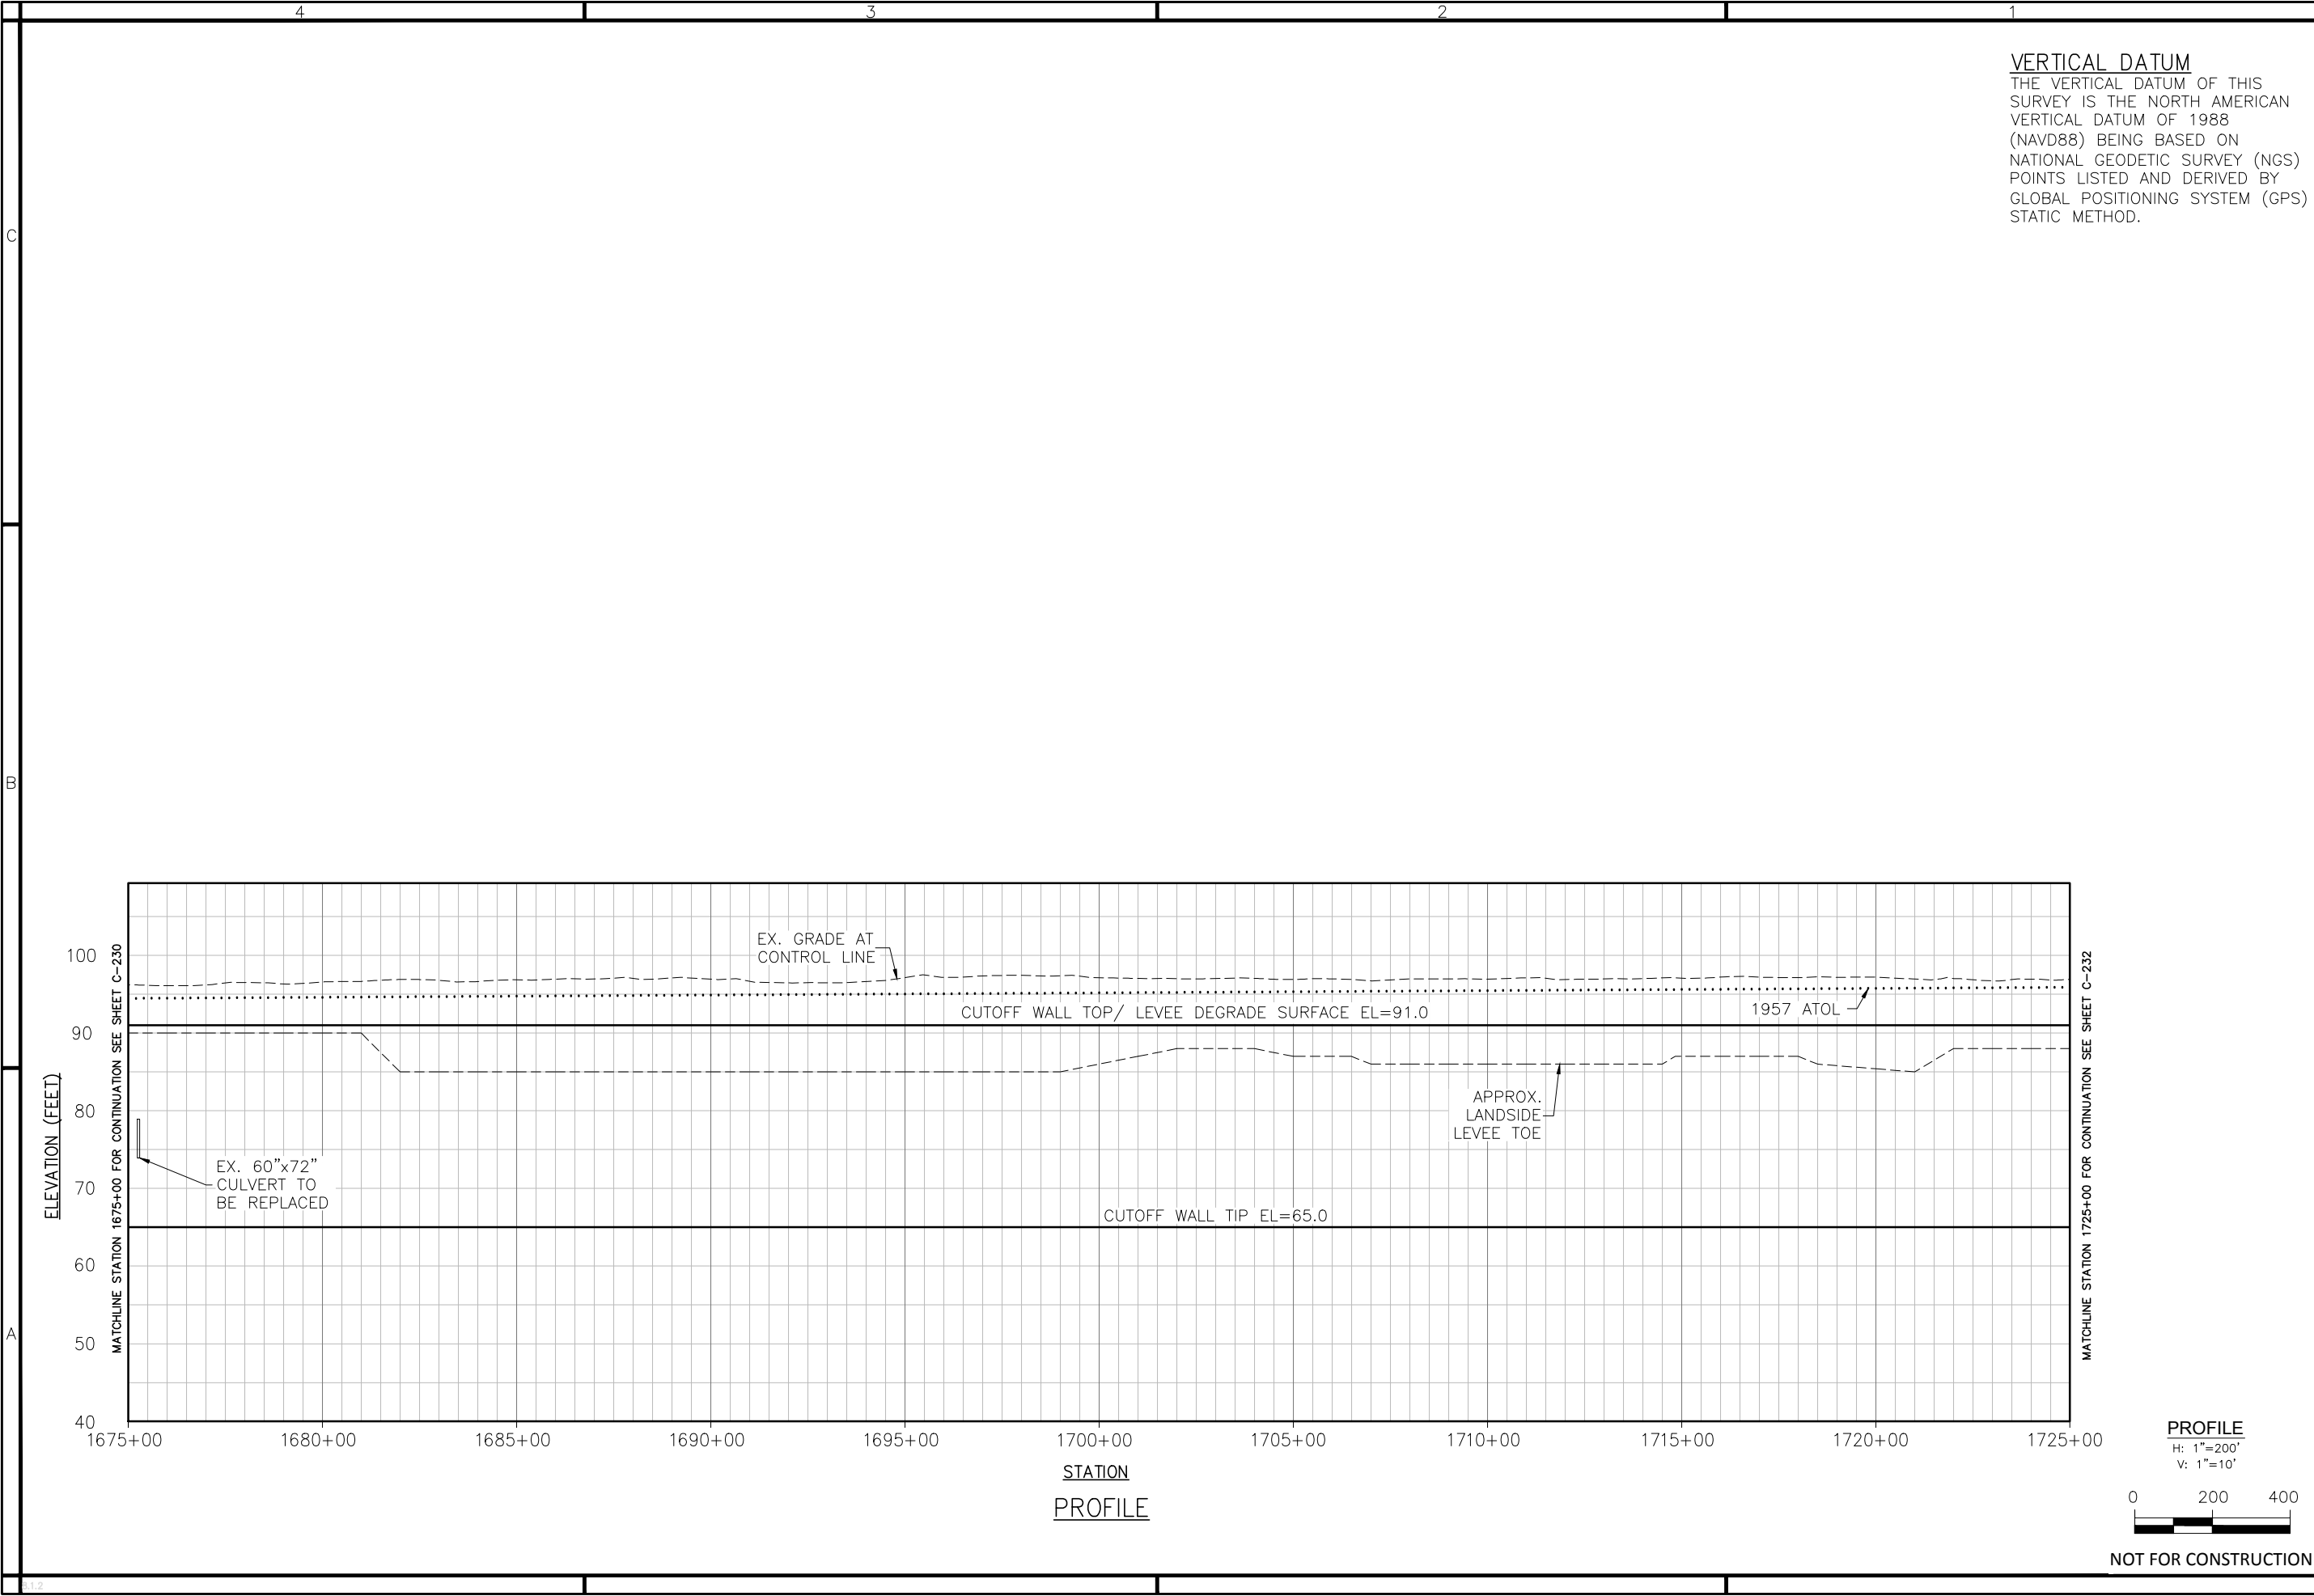

VERTICAL DATUM
THE VERTICAL DATUM OF THIS SURVEY IS THE NORTH AMERICAN VERTICAL DATUM OF 1988 (NAVD88) BEING BASED ON NATIONAL GEODETIC SURVEY (NGS) POINTS LISTED AND DERIVED BY GLOBAL POSITIONING SYSTEM (GPS) STATIC METHOD.



**US Army Corps
of Engineers**
Sacramento District

DATE	APPROVAL	DESCRIPTION	Rev.
	DATE7 APPROVAL	DESCRIPTION7	
	DATE6 APPROVAL	DESCRIPTION6	
	DATE5 APPROVAL	DESCRIPTION5	
	DATE4 APPROVAL	DESCRIPTION4	
	DATE3 APPROVAL	DESCRIPTION3	
	DATE2 APPROVAL	DESCRIPTION2	
	DATE1 APPROVAL	DESCRIPTION1	
	DATE	Symbol	Description

Designed by:	Date:	Rev.
—	—	—

Spec No.:	Design file no:
—	—

Drawn by:	Reviewed by:	Drawing Code:
—	—	—

Submitted by:	File name:	Plot date:	Plot scale:
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DEPARTMENT OF THE ARMY CORPS OF ENGINEERS SACRAMENTO, CALIFORNIA
SACRAMENTO DISTRICT IN-HOUSE DESIGN 1325 J STREET SACRAMENTO, CA 95814-2922


SUTTER & BUTTE COUNTY CALIFORNIA
SUTTER BASIN PILOT FEASIBILITY STUDY DRAFT REPORT ALTERNATIVE SB-8 PROFILE VIEW STA 1675+00 TO 1725+00

Sheet reference number:
C-231

C

B

A

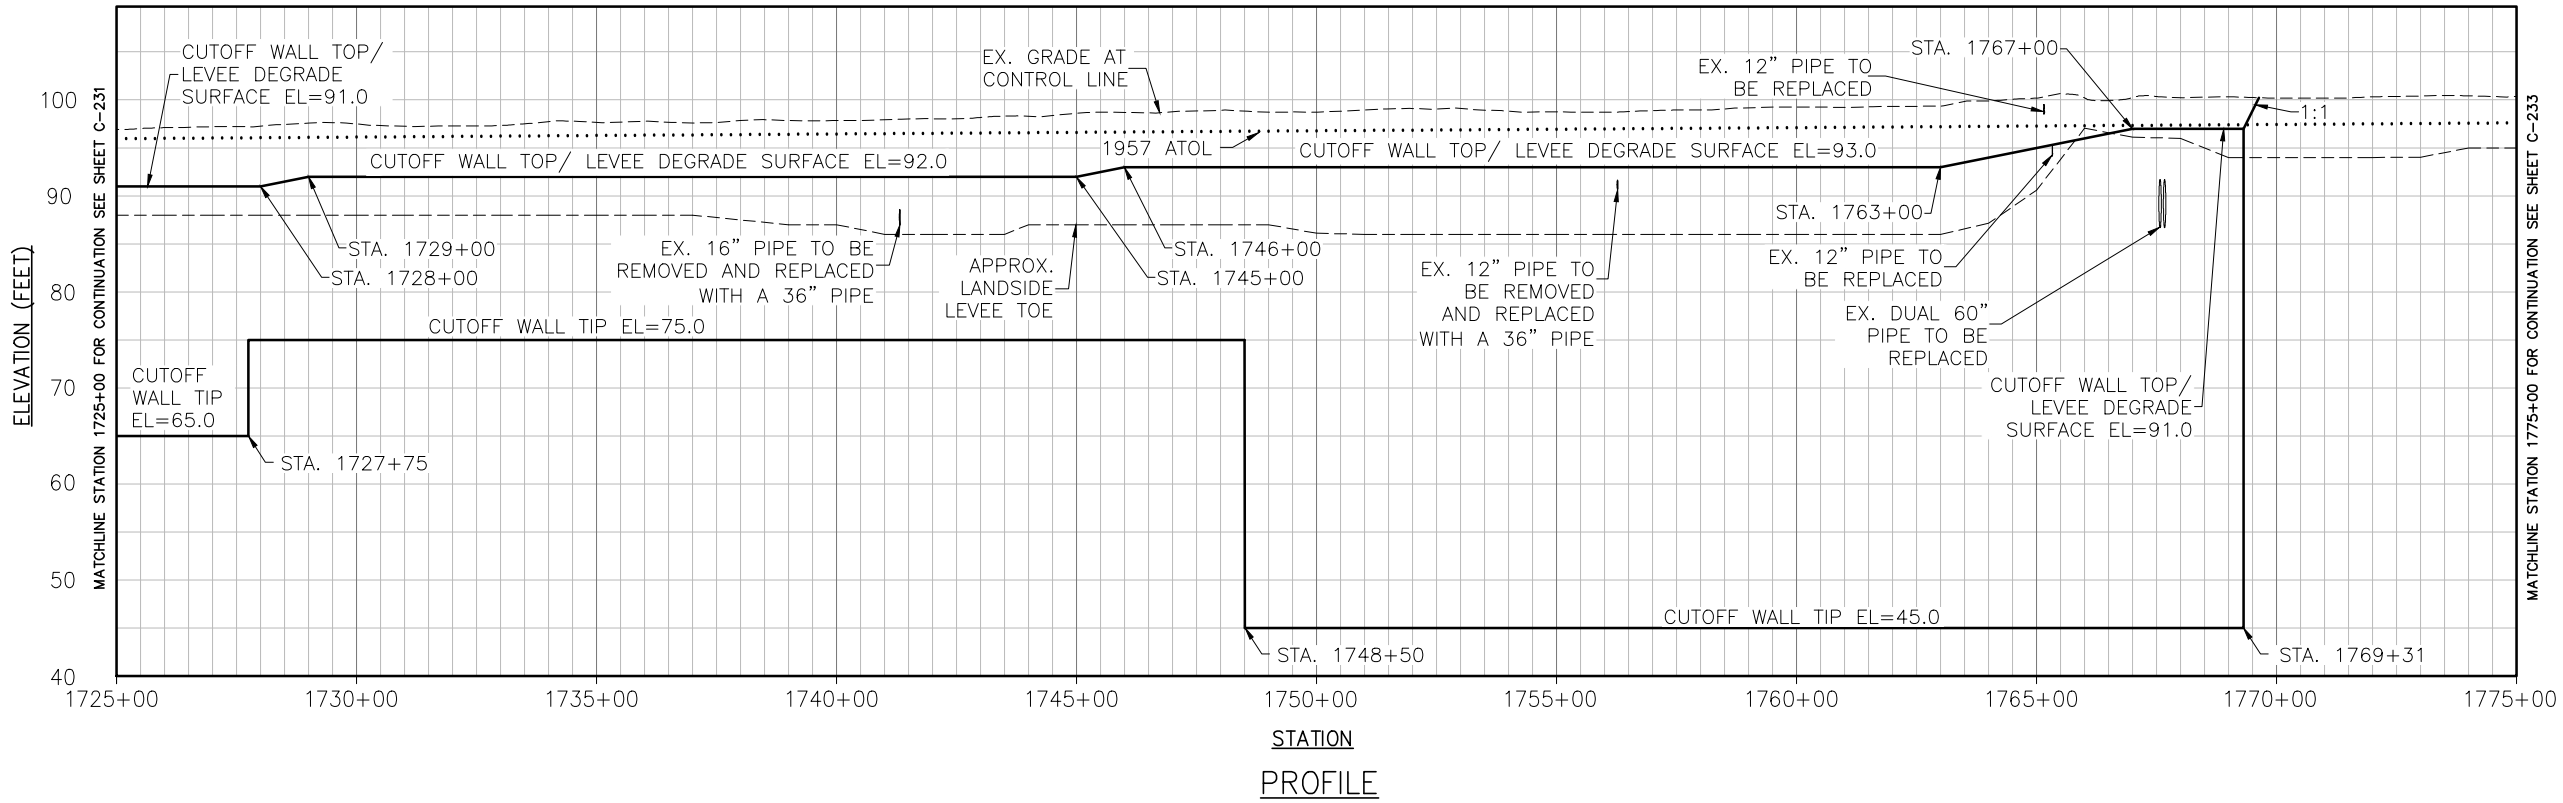

VERTICAL DATUM
THE VERTICAL DATUM OF THIS SURVEY IS THE NORTH AMERICAN VERTICAL DATUM OF 1988 (NAVD88) BEING BASED ON NATIONAL GEODETIC SURVEY (NGS) POINTS LISTED AND DERIVED BY GLOBAL POSITIONING SYSTEM (GPS) STATIC METHOD.

US Army Corps of Engineers
Sacramento District

DATE	APPROVAL	DESCRIPTION	Rev.
DATE7	APPROVAL	DESCRIPTION7	Rev.
DATE6	APPROVAL	DESCRIPTION6	Rev.
DATE5	APPROVAL	DESCRIPTION5	Rev.
DATE4	APPROVAL	DESCRIPTION4	Rev.
DATE3	APPROVAL	DESCRIPTION3	Rev.
DATE2	APPROVAL	DESCRIPTION2	Rev.
DATE1	APPROVAL	DESCRIPTION1	Rev.

Designed by: _____ Date: _____ Rev. _____

Dwn by: _____ Spec No.: _____ Design file no: _____

Reviewed by: _____ Drawing Code: _____

Submitted by: _____ File name: \$\$\$\$Mat-\$\$\$\$

CHEF, CIV ENR SES SEC A Plot date: _____ Plot scale: _____


DEPARTMENT OF THE ARMY
CORPS OF ENGINEERS
SACRAMENTO, CALIFORNIA

SACRAMENTO DISTRICT
IN-HOUSE DESIGN
1325 J STREET
SACRAMENTO, CA 95814-2922


SUTTER & BUTTE COUNTY CALIFORNIA

SUTTER BASIN PILOT FEASIBILITY STUDY
DRAFT REPORT
ALTERNATIVE SB-8
PROFILE VIEW
STA 1725+00 TO 1775+00

Sheet reference number:
C-232

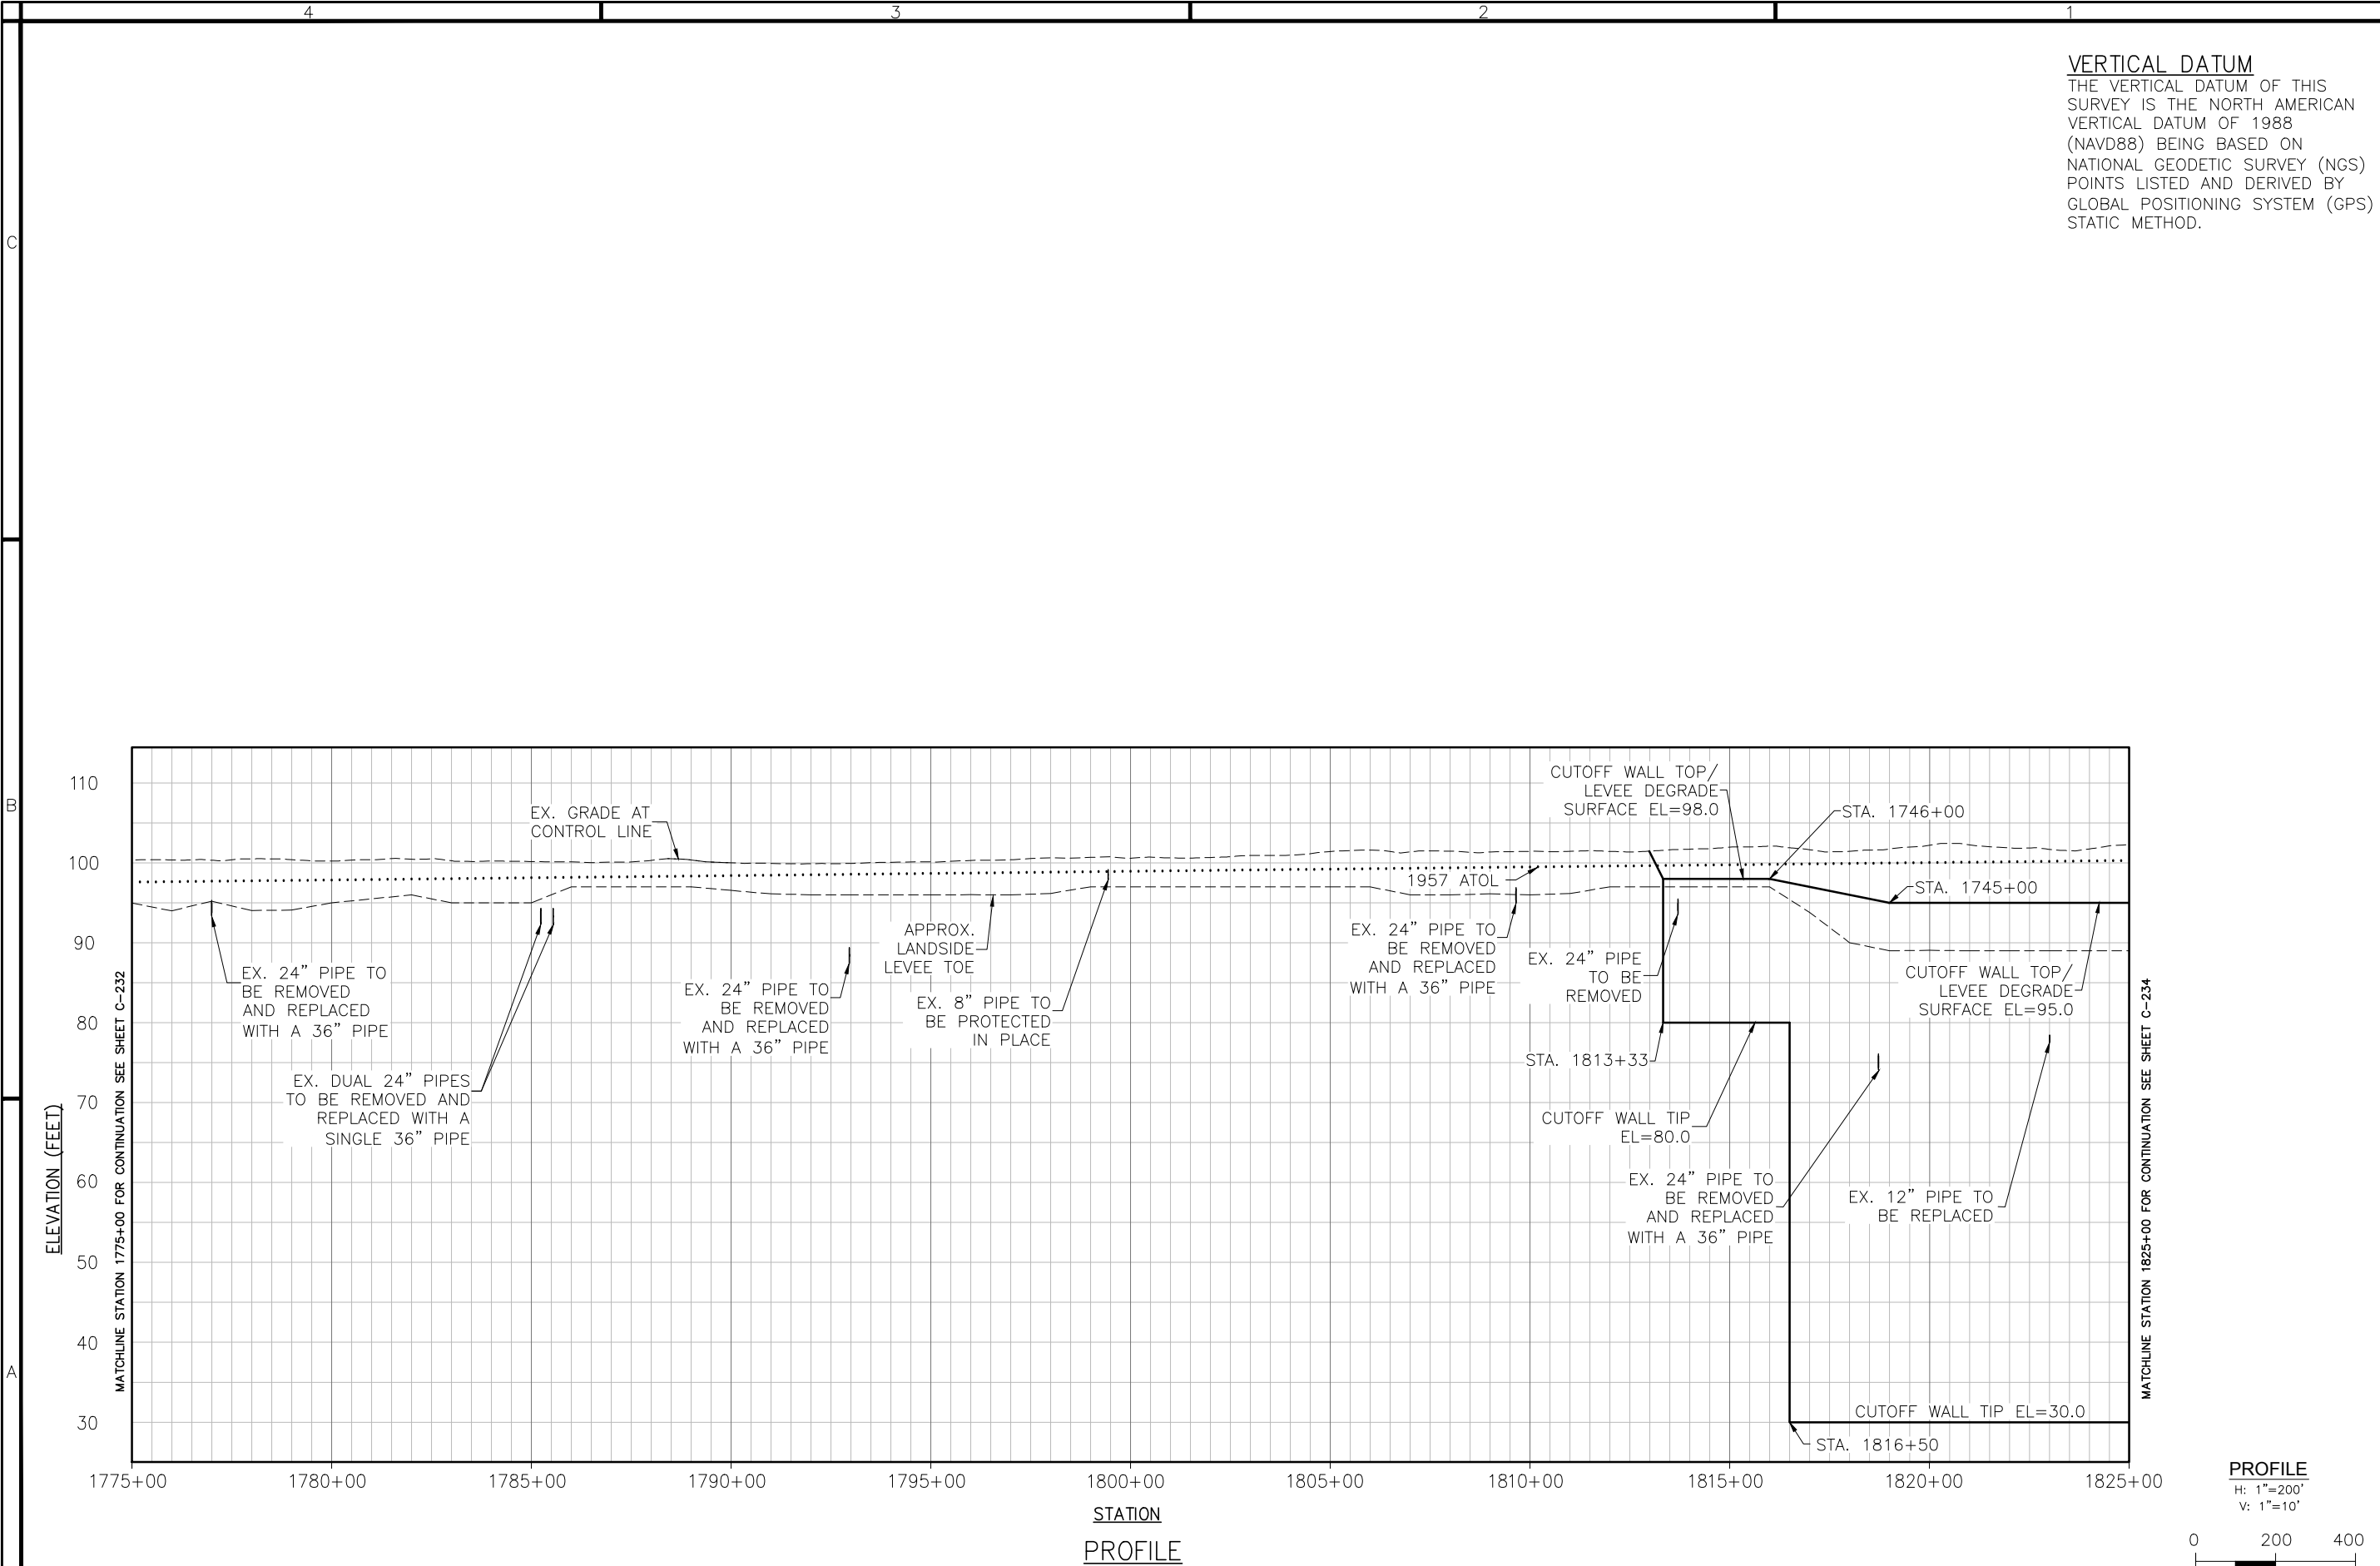

VERTICAL DATUM
THE VERTICAL DATUM OF THIS SURVEY IS THE NORTH AMERICAN VERTICAL DATUM OF 1988 (NAVD88) BEING BASED ON NATIONAL GEODETIC SURVEY (NGS) POINTS LISTED AND DERIVED BY GLOBAL POSITIONING SYSTEM (GPS) STATIC METHOD.



US Army Corps
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Sacramento District

Rev.	Date	Rev.
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DESCRIPTION	DATE/ APPROVAL
DESCRIPTION 8	DATE/ APPROVAL
DESCRIPTION 7	DATE/ APPROVAL
DESCRIPTION 6	DATE/ APPROVAL
DESCRIPTION 5	DATE/ APPROVAL
DESCRIPTION 4	DATE/ APPROVAL
DESCRIPTION 3	DATE/ APPROVAL
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DESCRIPTION 1	DATE/ APPROVAL

Symbol	Description

Designated by	Date	Rev.

Spec No.	Design file no.


Drawn by	Reviewed by

Drawing Code	File name
	\$\$\$Mat-\$\$\$


Submitted by	Plot date	Plot scale
CHIEF, CIV ENR SES SEC A		

DEPARTMENT OF THE ARMY CORPS OF ENGINEERS SACRAMENTO, CALIFORNIA	SACRAMENTO DISTRICT IN-HOUSE DESIGN 1325 J STREET SACRAMENTO, CA 95814-2922
SUTTER & BUTTE COUNTY CALIFORNIA	ALTERNATIVE SB-8 PROFILE VIEW STA 1775+00 TO 1825+00

Sheet reference number:
C-233

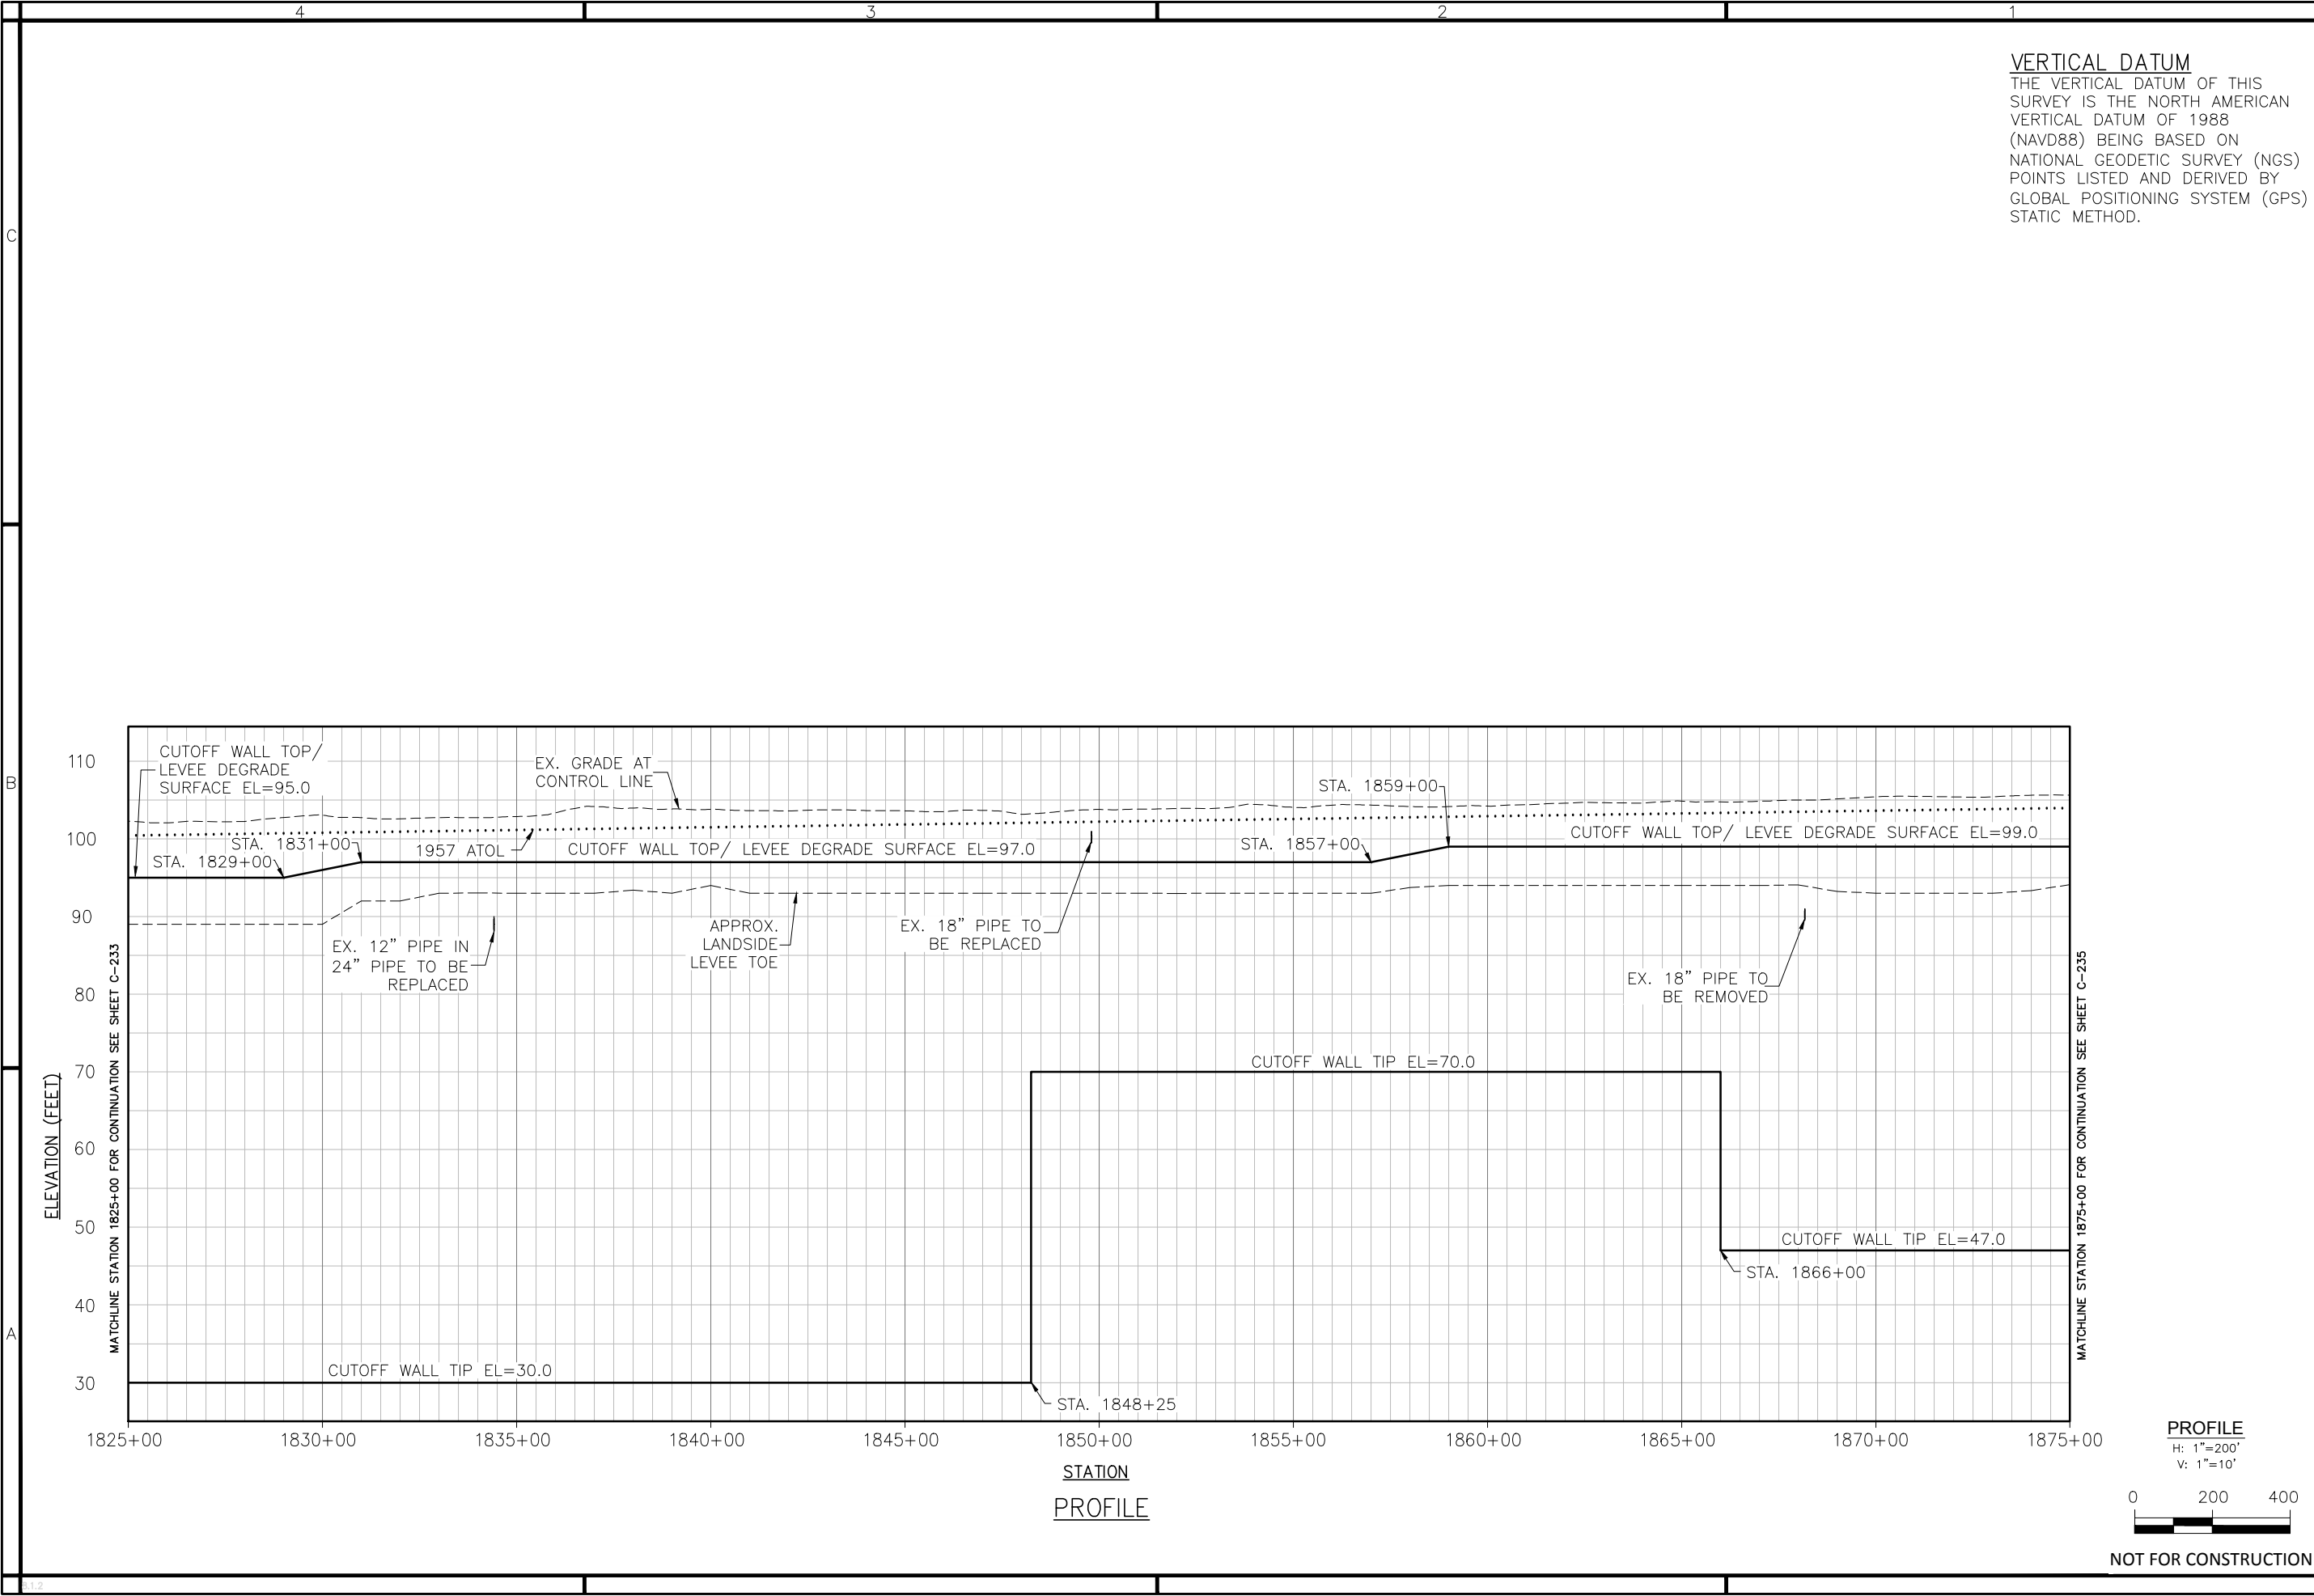

VERTICAL DATUM
THE VERTICAL DATUM OF THIS SURVEY IS THE NORTH AMERICAN VERTICAL DATUM OF 1988 (NAVD88) BEING BASED ON NATIONAL GEODETIC SURVEY (NGS) POINTS LISTED AND DERIVED BY GLOBAL POSITIONING SYSTEM (GPS) STATIC METHOD.



US Army Corps
of Engineers
Sacramento District

DATE	APPROVAL	DESCRIPTION	DATE	APPROVAL	DESCRIPTION
		DESCRIPTION 8			
		DESCRIPTION 7			
		DESCRIPTION 6			
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DESIGNED BY	DATE	REV.

DRAWN BY	DATE	REV.

REVIEWED BY	DATE	REV.


SUBMITTED BY	DATE	REV.

DEPARTMENT OF THE ARMY
CORPS OF ENGINEERS
SACRAMENTO, CALIFORNIA


SACRAMENTO DISTRICT
IN-HOUSE DESIGN
1325 J STREET
SACRAMENTO, CA 95814-2922

SUTTER & BUTTE COUNTY CALIFORNIA
SUTTER BASIN PILOT FEASIBILITY STUDY
DRAFT REPORT
ALTERNATIVE SB-8
PROFILE VIEW
STA 1825+00 TO 1875+00

Sheet
reference
number:
C-234

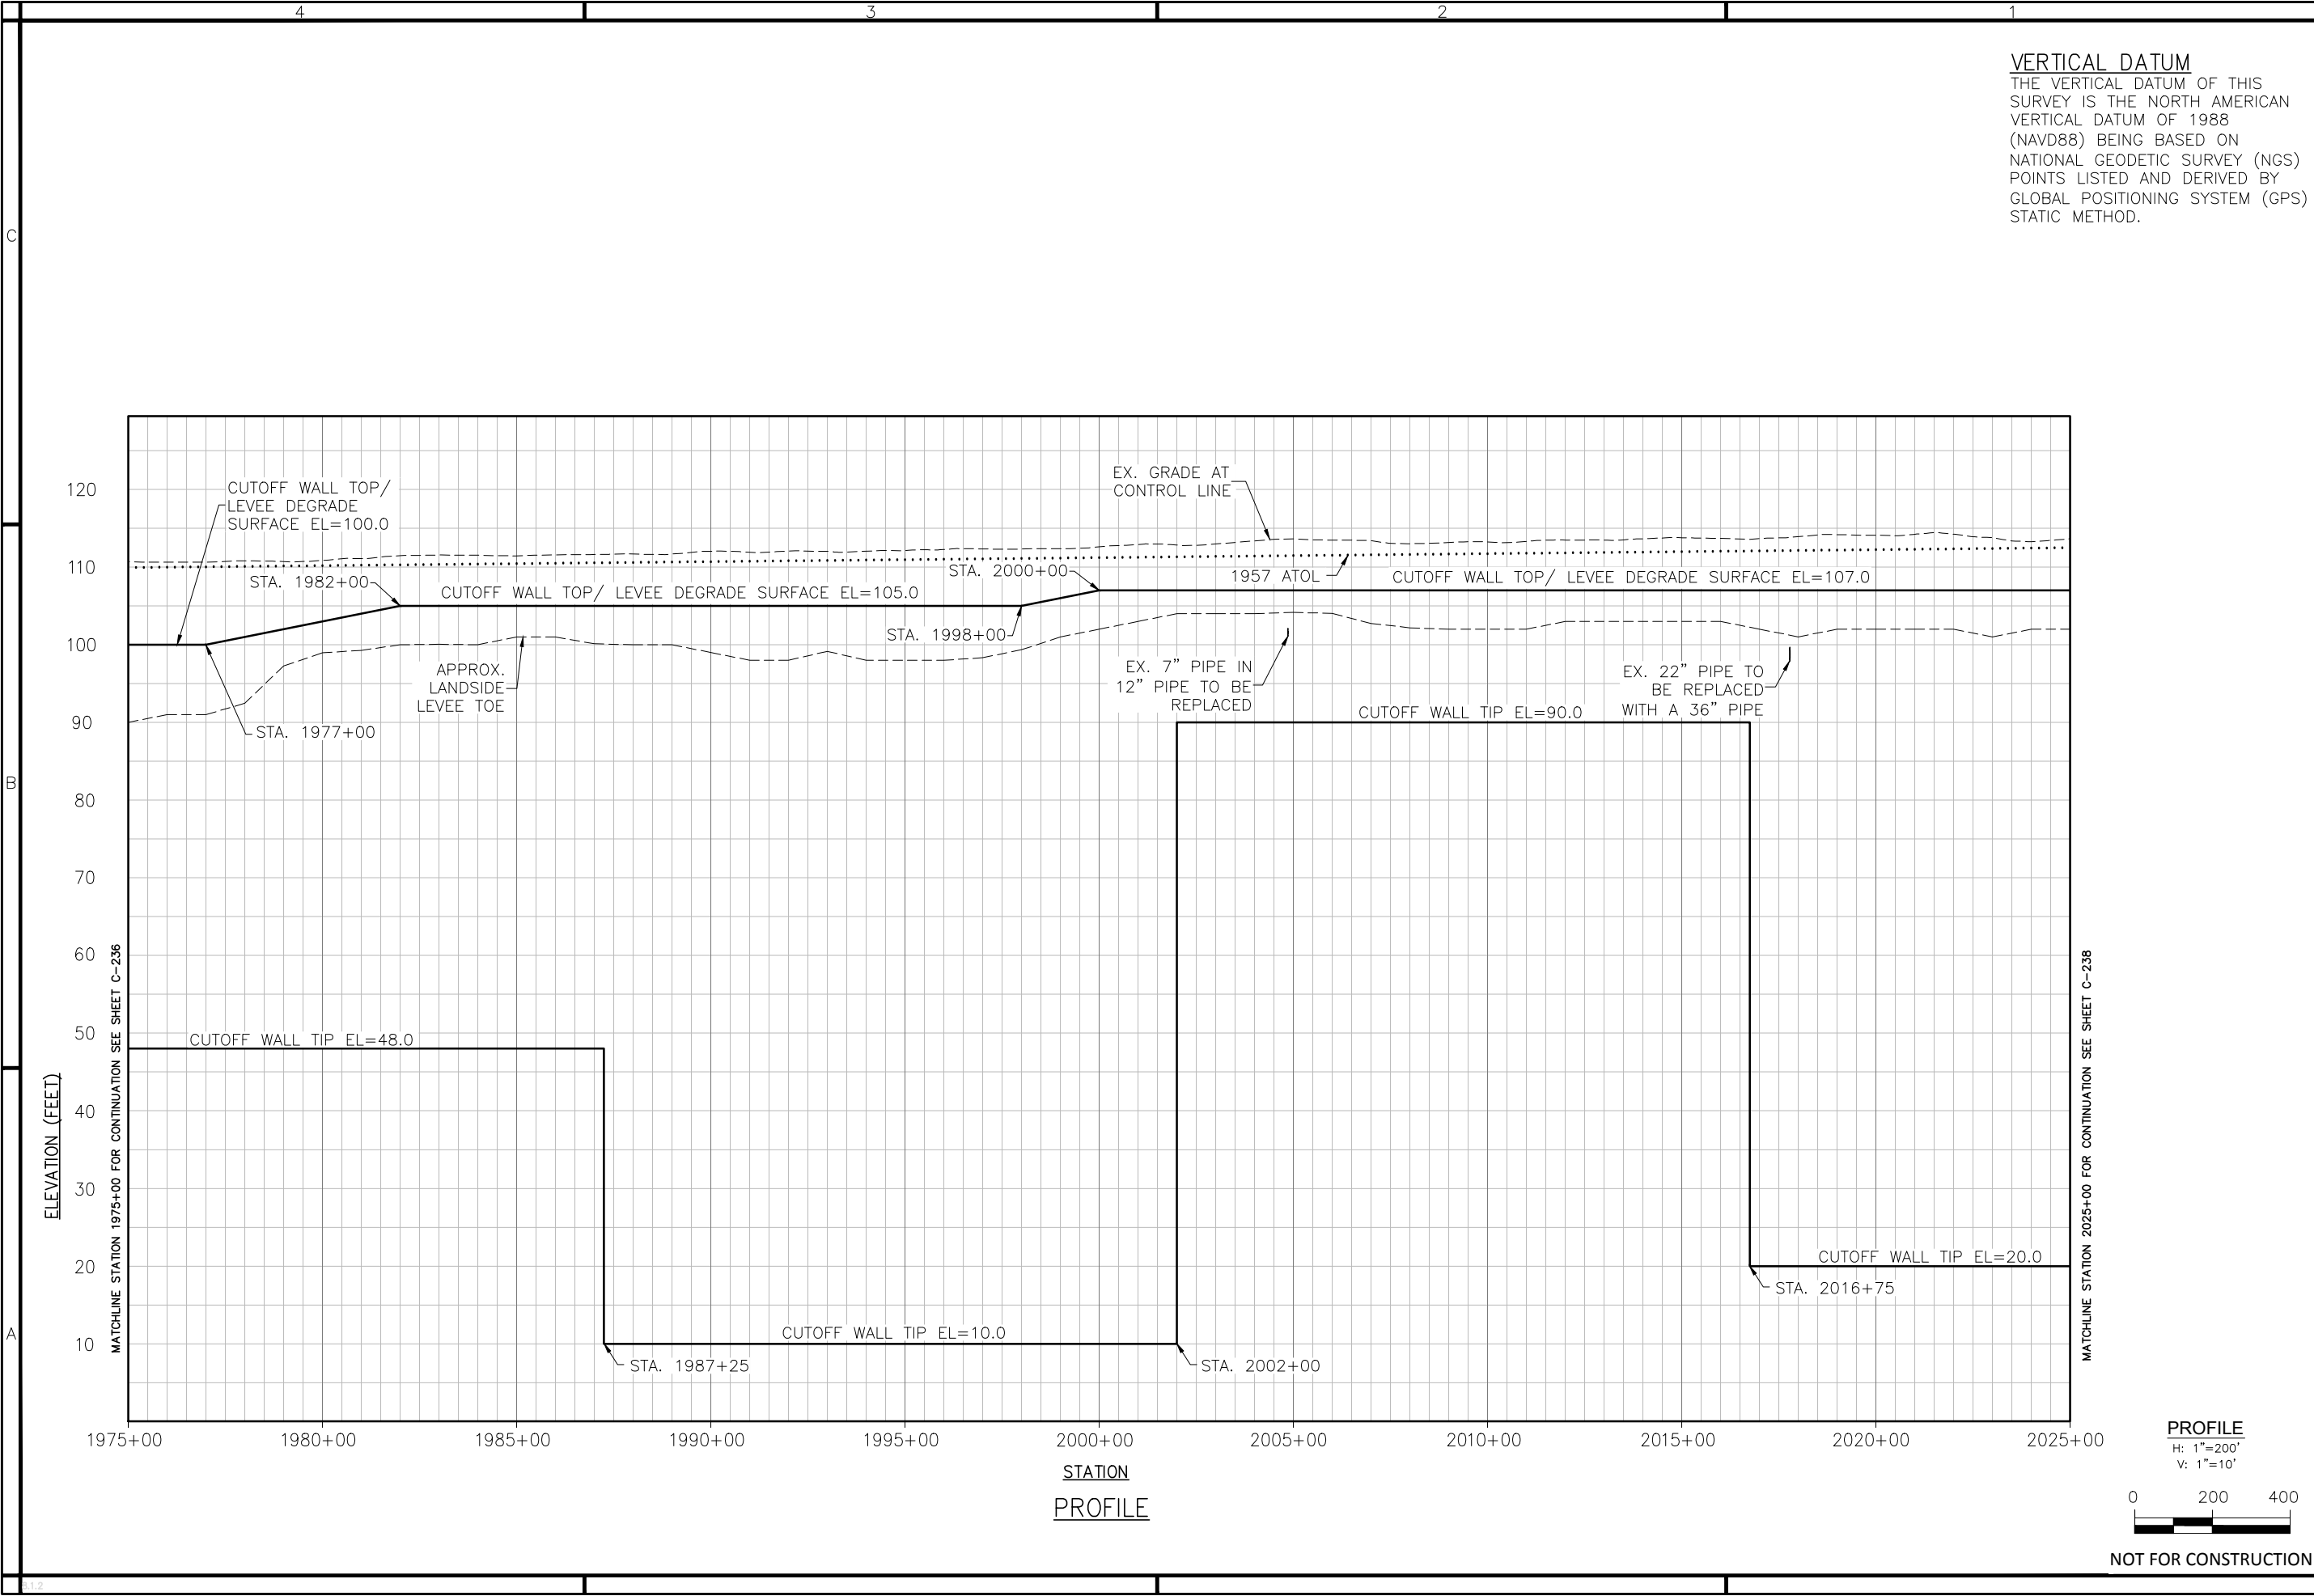

THE VERTICAL DATUM OF THIS SURVEY IS THE NORTH AMERICAN VERTICAL DATUM OF 1988 (NAVD88) BEING BASED ON NATIONAL GEODETIC SURVEY (NGS) POINTS LISTED AND DERIVED BY GLOBAL POSITIONING SYSTEM (GPS) STATIC METHOD.

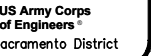


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DEPARTMENT OF THE ARMY CORPS OF ENGINEERS SACRAMENTO, CALIFORNIA	Designated by: _____ Date: _____		Review: _____
	Drawn by: _____	Spec. No.: _____	Design file no.: _____
	Reviewed by: _____ Drawing Code: _____		
	Submitted by: _____ File name: _____ _____ Plot date: _____ Plot scale: _____ CHIEF, CIV. ENGR. DES. SEC. A		

SUTTER & BUTTE COUNTY CALIFORNIA
SUTTER BASIN PILOT FEASIBILITY STUDY
DRAFT REPORT
ALTERNATIVE SB-8
PROFILE VIEW
STA 2075+00 TO 2125+00

Sheet
reference
number:
C-239

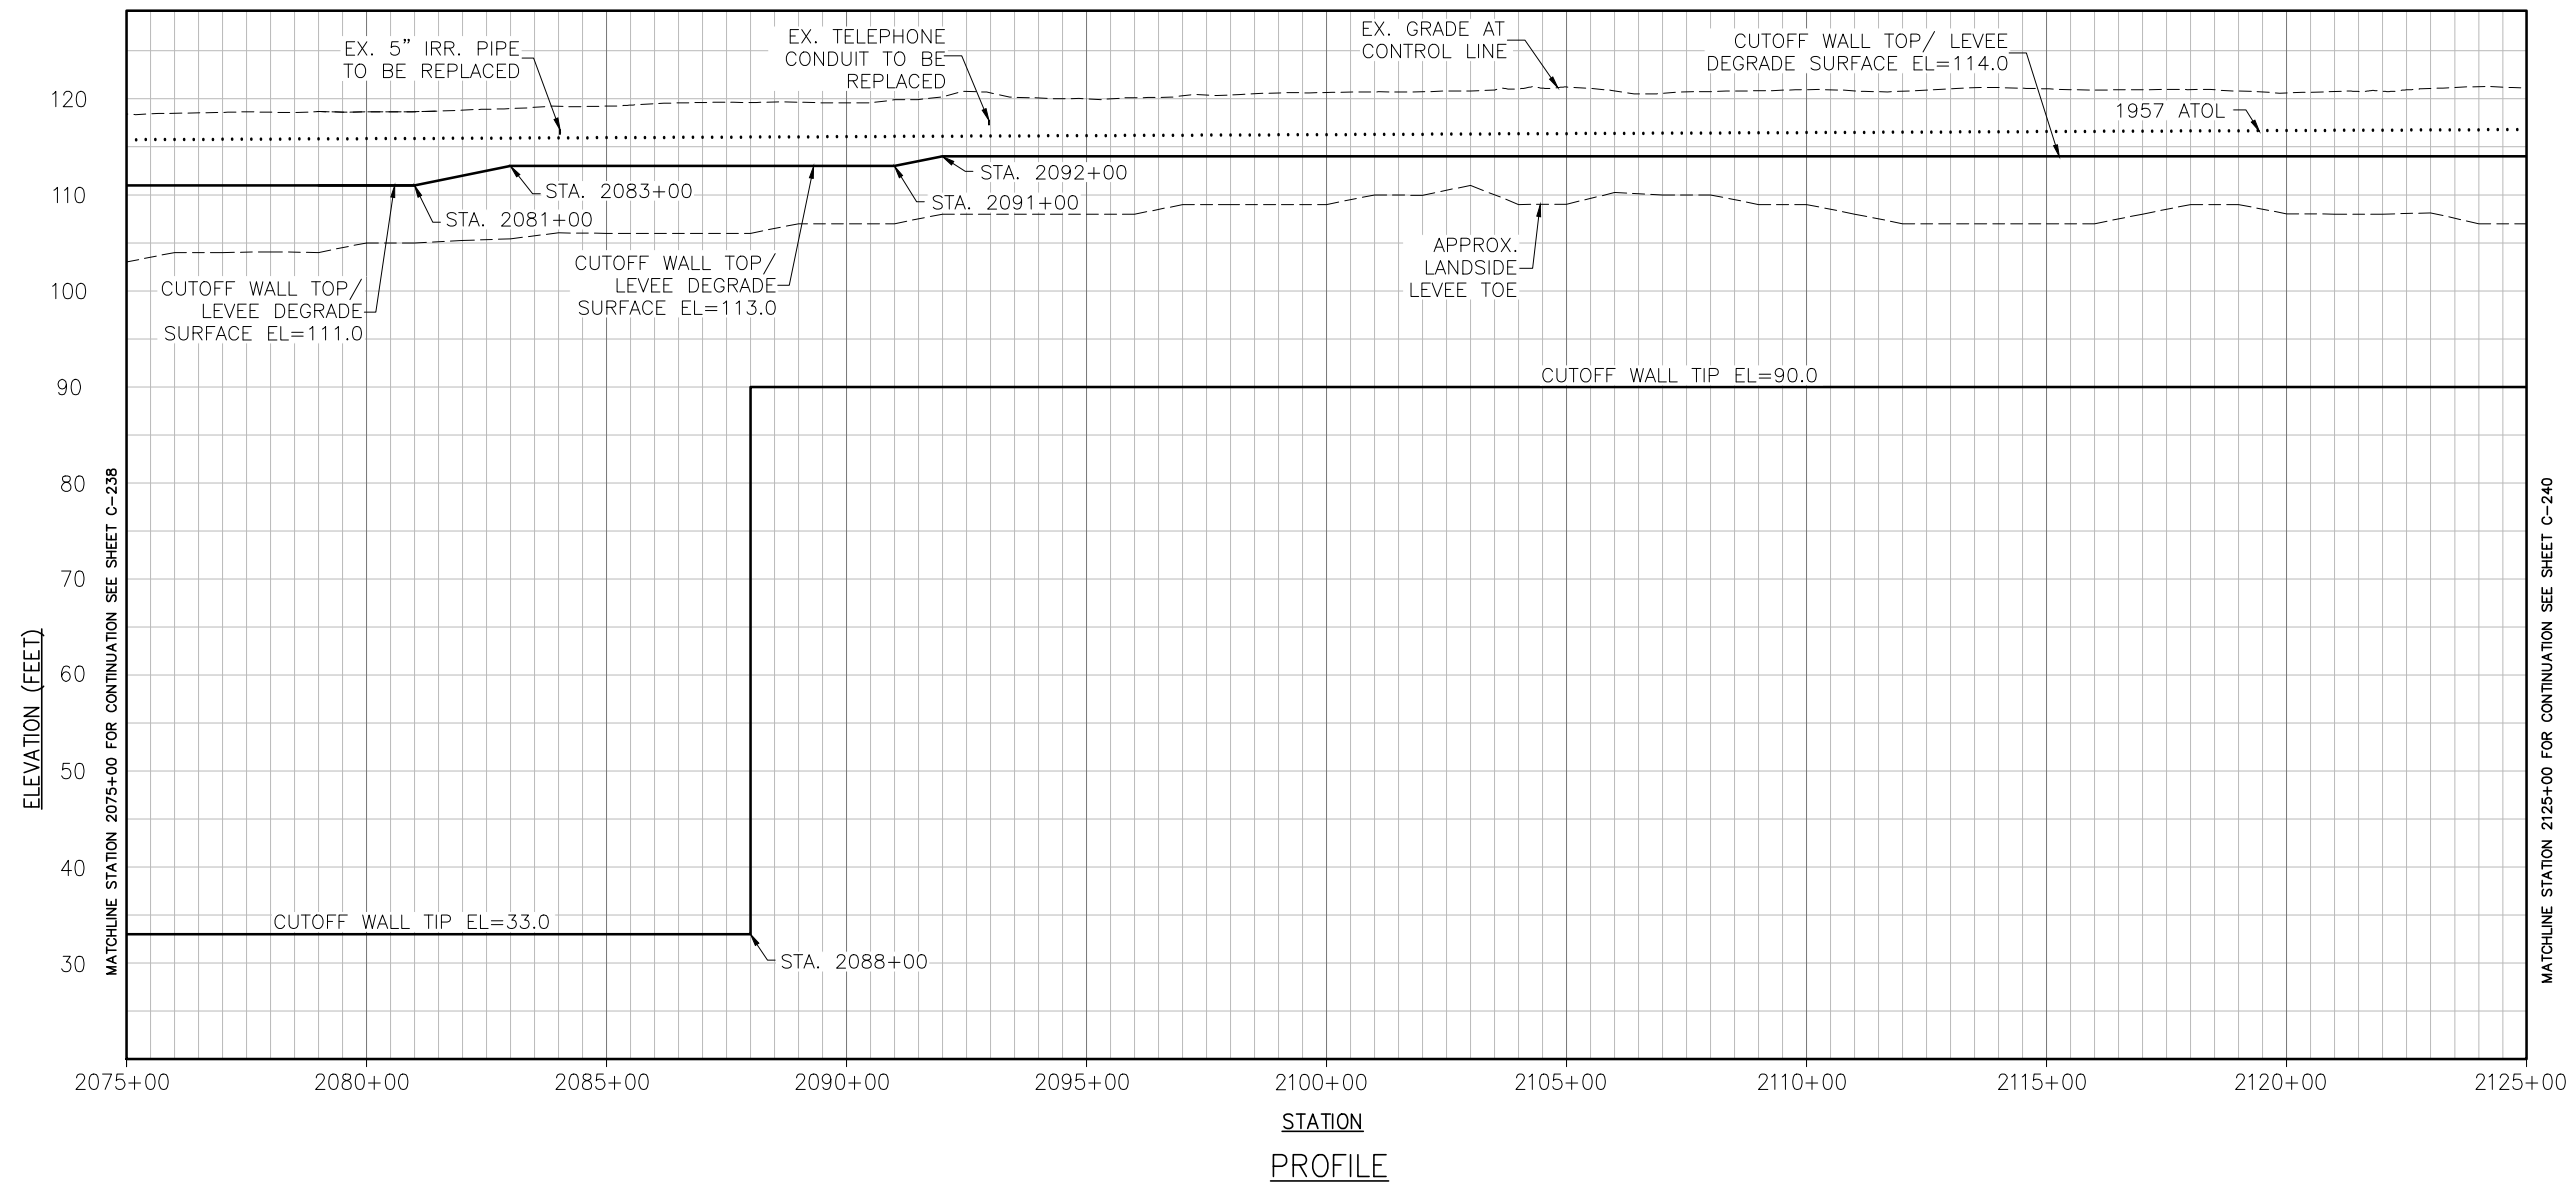


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
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VERTICAL DATUM
THE VERTICAL DATUM OF THIS SURVEY IS THE NORTH AMERICAN VERTICAL DATUM OF 1988 (NAVD88) BEING BASED ON NATIONAL GEODETIC SURVEY (NGS) POINTS LISTED AND DERIVED BY GLOBAL POSITIONING SYSTEM (GPS) STATIC METHOD.



US Army Corps
of Engineers
Sacramento District

DATE/ APPROVAL	DESCRIPTION	Rev.
DATE/ APPROVAL	DESCRIPTION8	Rev.
DATE/ APPROVAL	DESCRIPTION7	Rev.
DATE/ APPROVAL	DESCRIPTION6	Rev.
DATE/ APPROVAL	DESCRIPTION5	Rev.
DATE/ APPROVAL	DESCRIPTION4	Rev.
DATE/ APPROVAL	DESCRIPTION3	Rev.
DATE/ APPROVAL	DESCRIPTION2	Rev.
DATE/ APPROVAL	DESCRIPTION1	Rev.

DESIGNED BY	DATE	REV.
DESIGNED BY	DATE	REV.
DWN BY	DESIGN FILE NO.	
REVIEWED BY	DRAWING CODE	
SUBMITTED BY	FILE NAME	
CHEF, CIV ENR SES SEC A	PLOT DATE	
	PLOT SCALE	

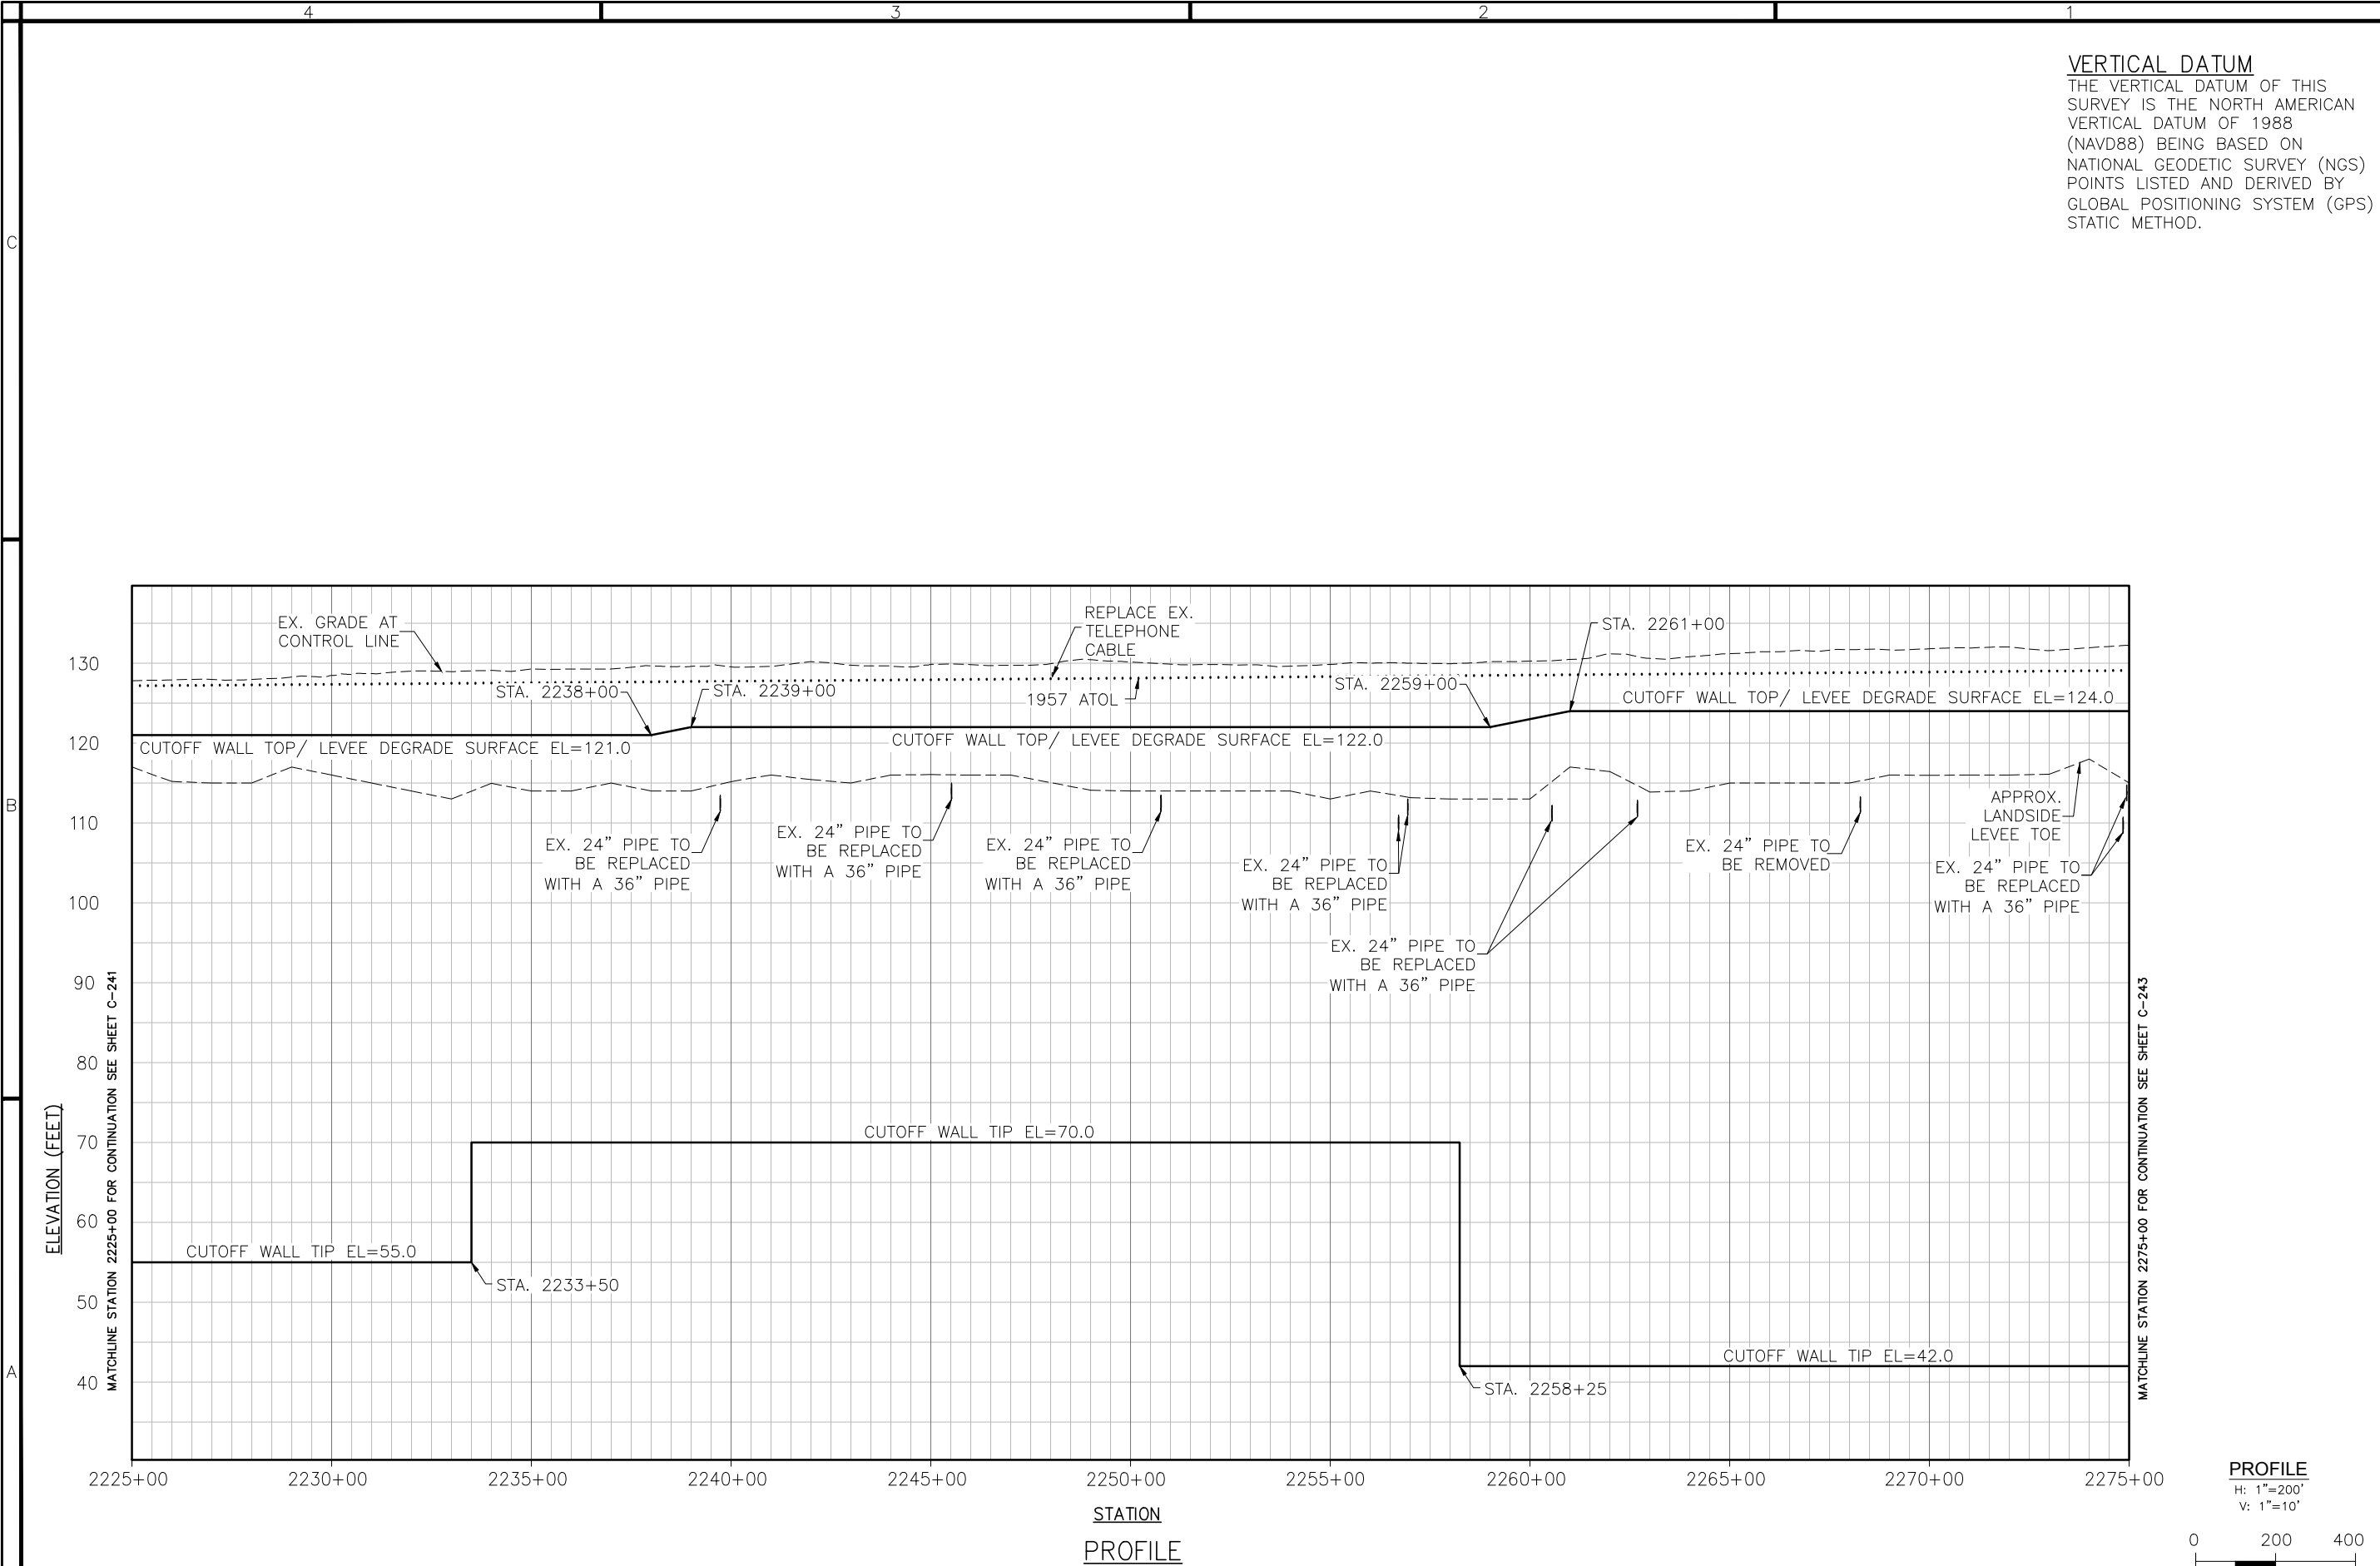
DEPARTMENT OF THE ARMY
CORPS OF ENGINEERS
SACRAMENTO, CALIFORNIA

SACRAMENTO DISTRICT
IN-HOUSE DESIGN
1325 J STREET
SACRAMENTO, CA 95814-2922

SUTTER & BUTTE COUNTY CALIFORNIA

SUTTER BASIN PILOT FEASIBILITY STUDY
DRAFT REPORT
ALTERNATIVE SB-8
PROFILE VIEW
STA 2225+00 TO 2275+00

Sheet
reference
number:
C-242

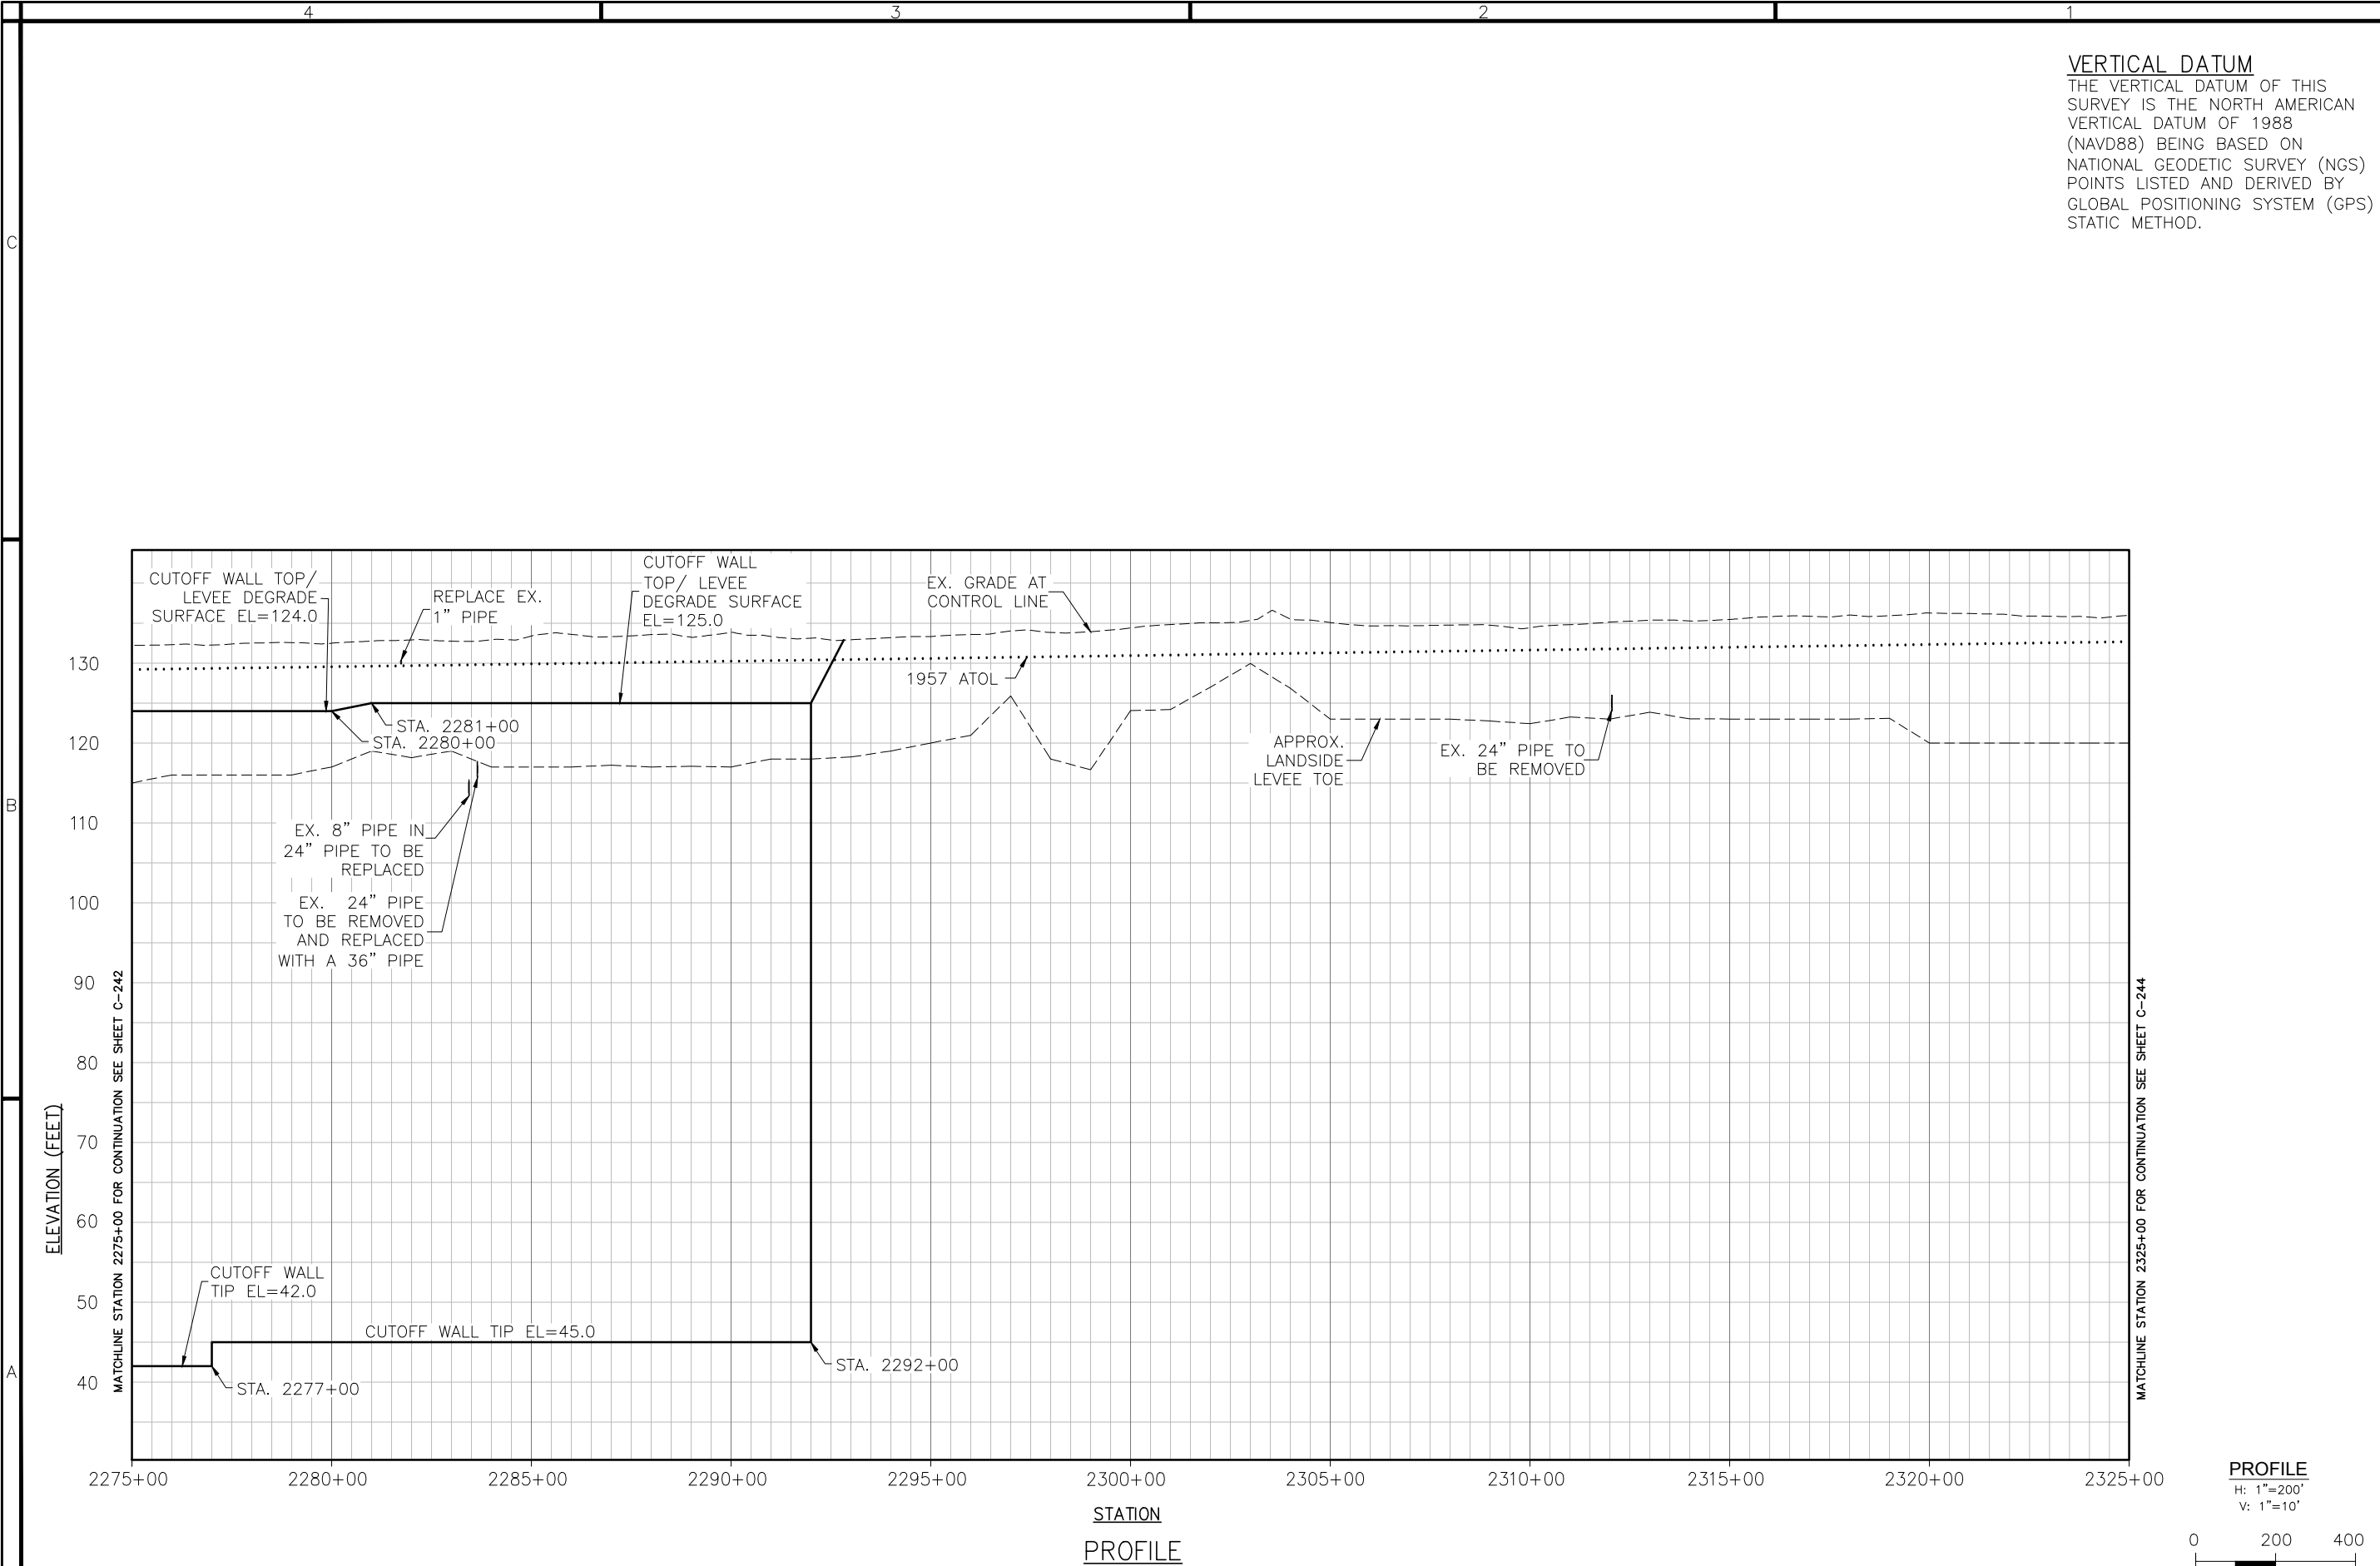

US Army Corps of Engineers
Sacramento District

DATE	APPROVAL	DESCRIPTION	Rev.
	DATE7 APPROVAL	DESCRIPTION7	
	DATE6 APPROVAL	DESCRIPTION6	
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	DATE4 APPROVAL	DESCRIPTION4	
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	DATE2 APPROVAL	DESCRIPTION2	
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Designed by:	Date:	Rev.

Dwn by:	Spec No.:	Design file no.:

Reviewed by:	Drawing Code:	File name:
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Submitted by:	Plot date:	Plot scale:
CHIEF, CIV ENGR DES SEC. A		


DEPARTMENT OF THE ARMY
CORPS OF ENGINEERS
SACRAMENTO, CALIFORNIA

SACRAMENTO DISTRICT
IN-HOUSE DESIGN
1325 J STREET
SACRAMENTO, CA 95814-2922


SUTTER & BUTTE COUNTY CALIFORNIA

SUTTER BASIN PILOT FEASIBILITY STUDY
DRAFT REPORT
ALTERNATIVE SB-8
PROFILE VIEW
STA 2275+00 TO 2325+00

Sheet reference number:
C-243

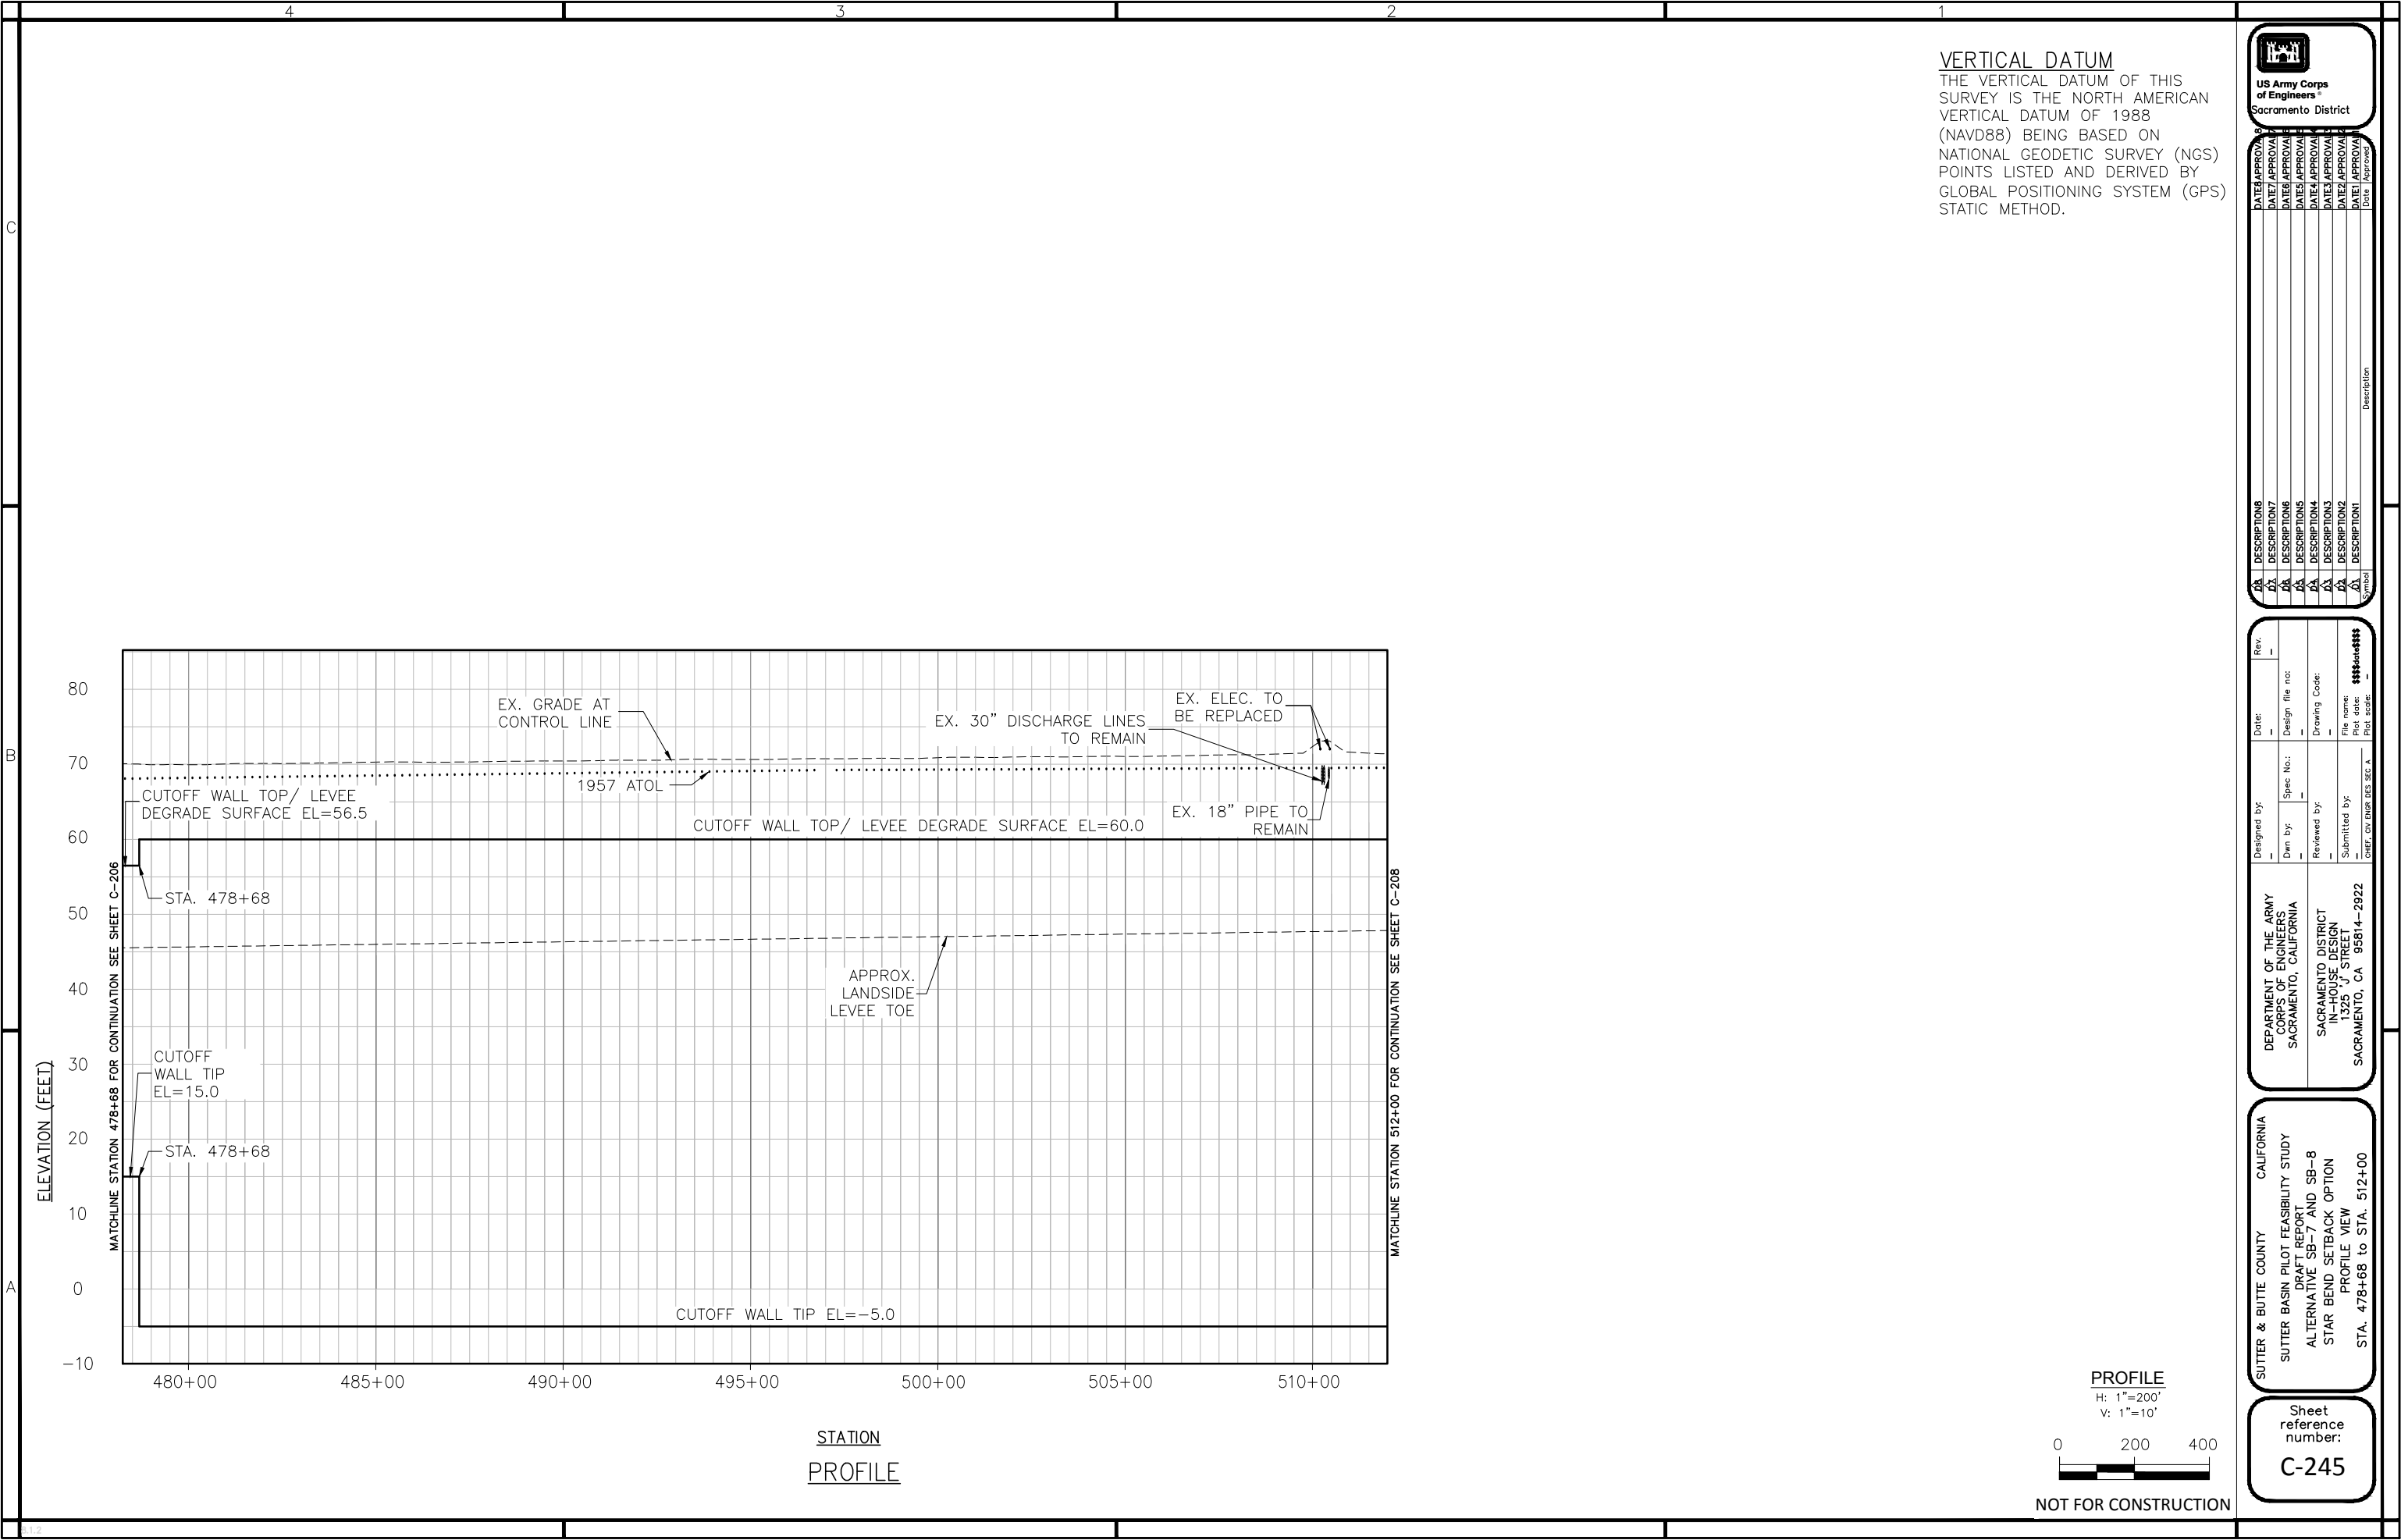

VERTICAL DATUM
THE VERTICAL DATUM OF THIS SURVEY IS THE NORTH AMERICAN VERTICAL DATUM OF 1988 (NAVD88) BEING BASED ON NATIONAL GEODETIC SURVEY (NGS) POINTS LISTED AND DERIVED BY GLOBAL POSITIONING SYSTEM (GPS) STATIC METHOD.



US Army Corps
of Engineers
Sacramento District

DATE	APPROVAL	DESCRIPTION	Rev.
	DATE7	DESCRIPTION7	
	DATE6	DESCRIPTION6	
	DATE5	DESCRIPTION5	
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DEPARTMENT OF THE ARMY
CORPS OF ENGINEERS
SACRAMENTO, CALIFORNIA


SACRAMENTO DISTRICT
IN-HOUSE DESIGN
1325 J STREET
SACRAMENTO, CA 95814-2922

SUTTER & BUTTE COUNTY

CALIFORNIA

SUTTER BASIN PILOT FEASIBILITY STUDY
DRAFT REPORT
ALTERNATIVE SB-7 AND SB-8
STAR BEND SETBACK OPTION
PROFILE VIEW
STA. 478+68 to STA. 512+00

Sheet
reference
number:
C-245

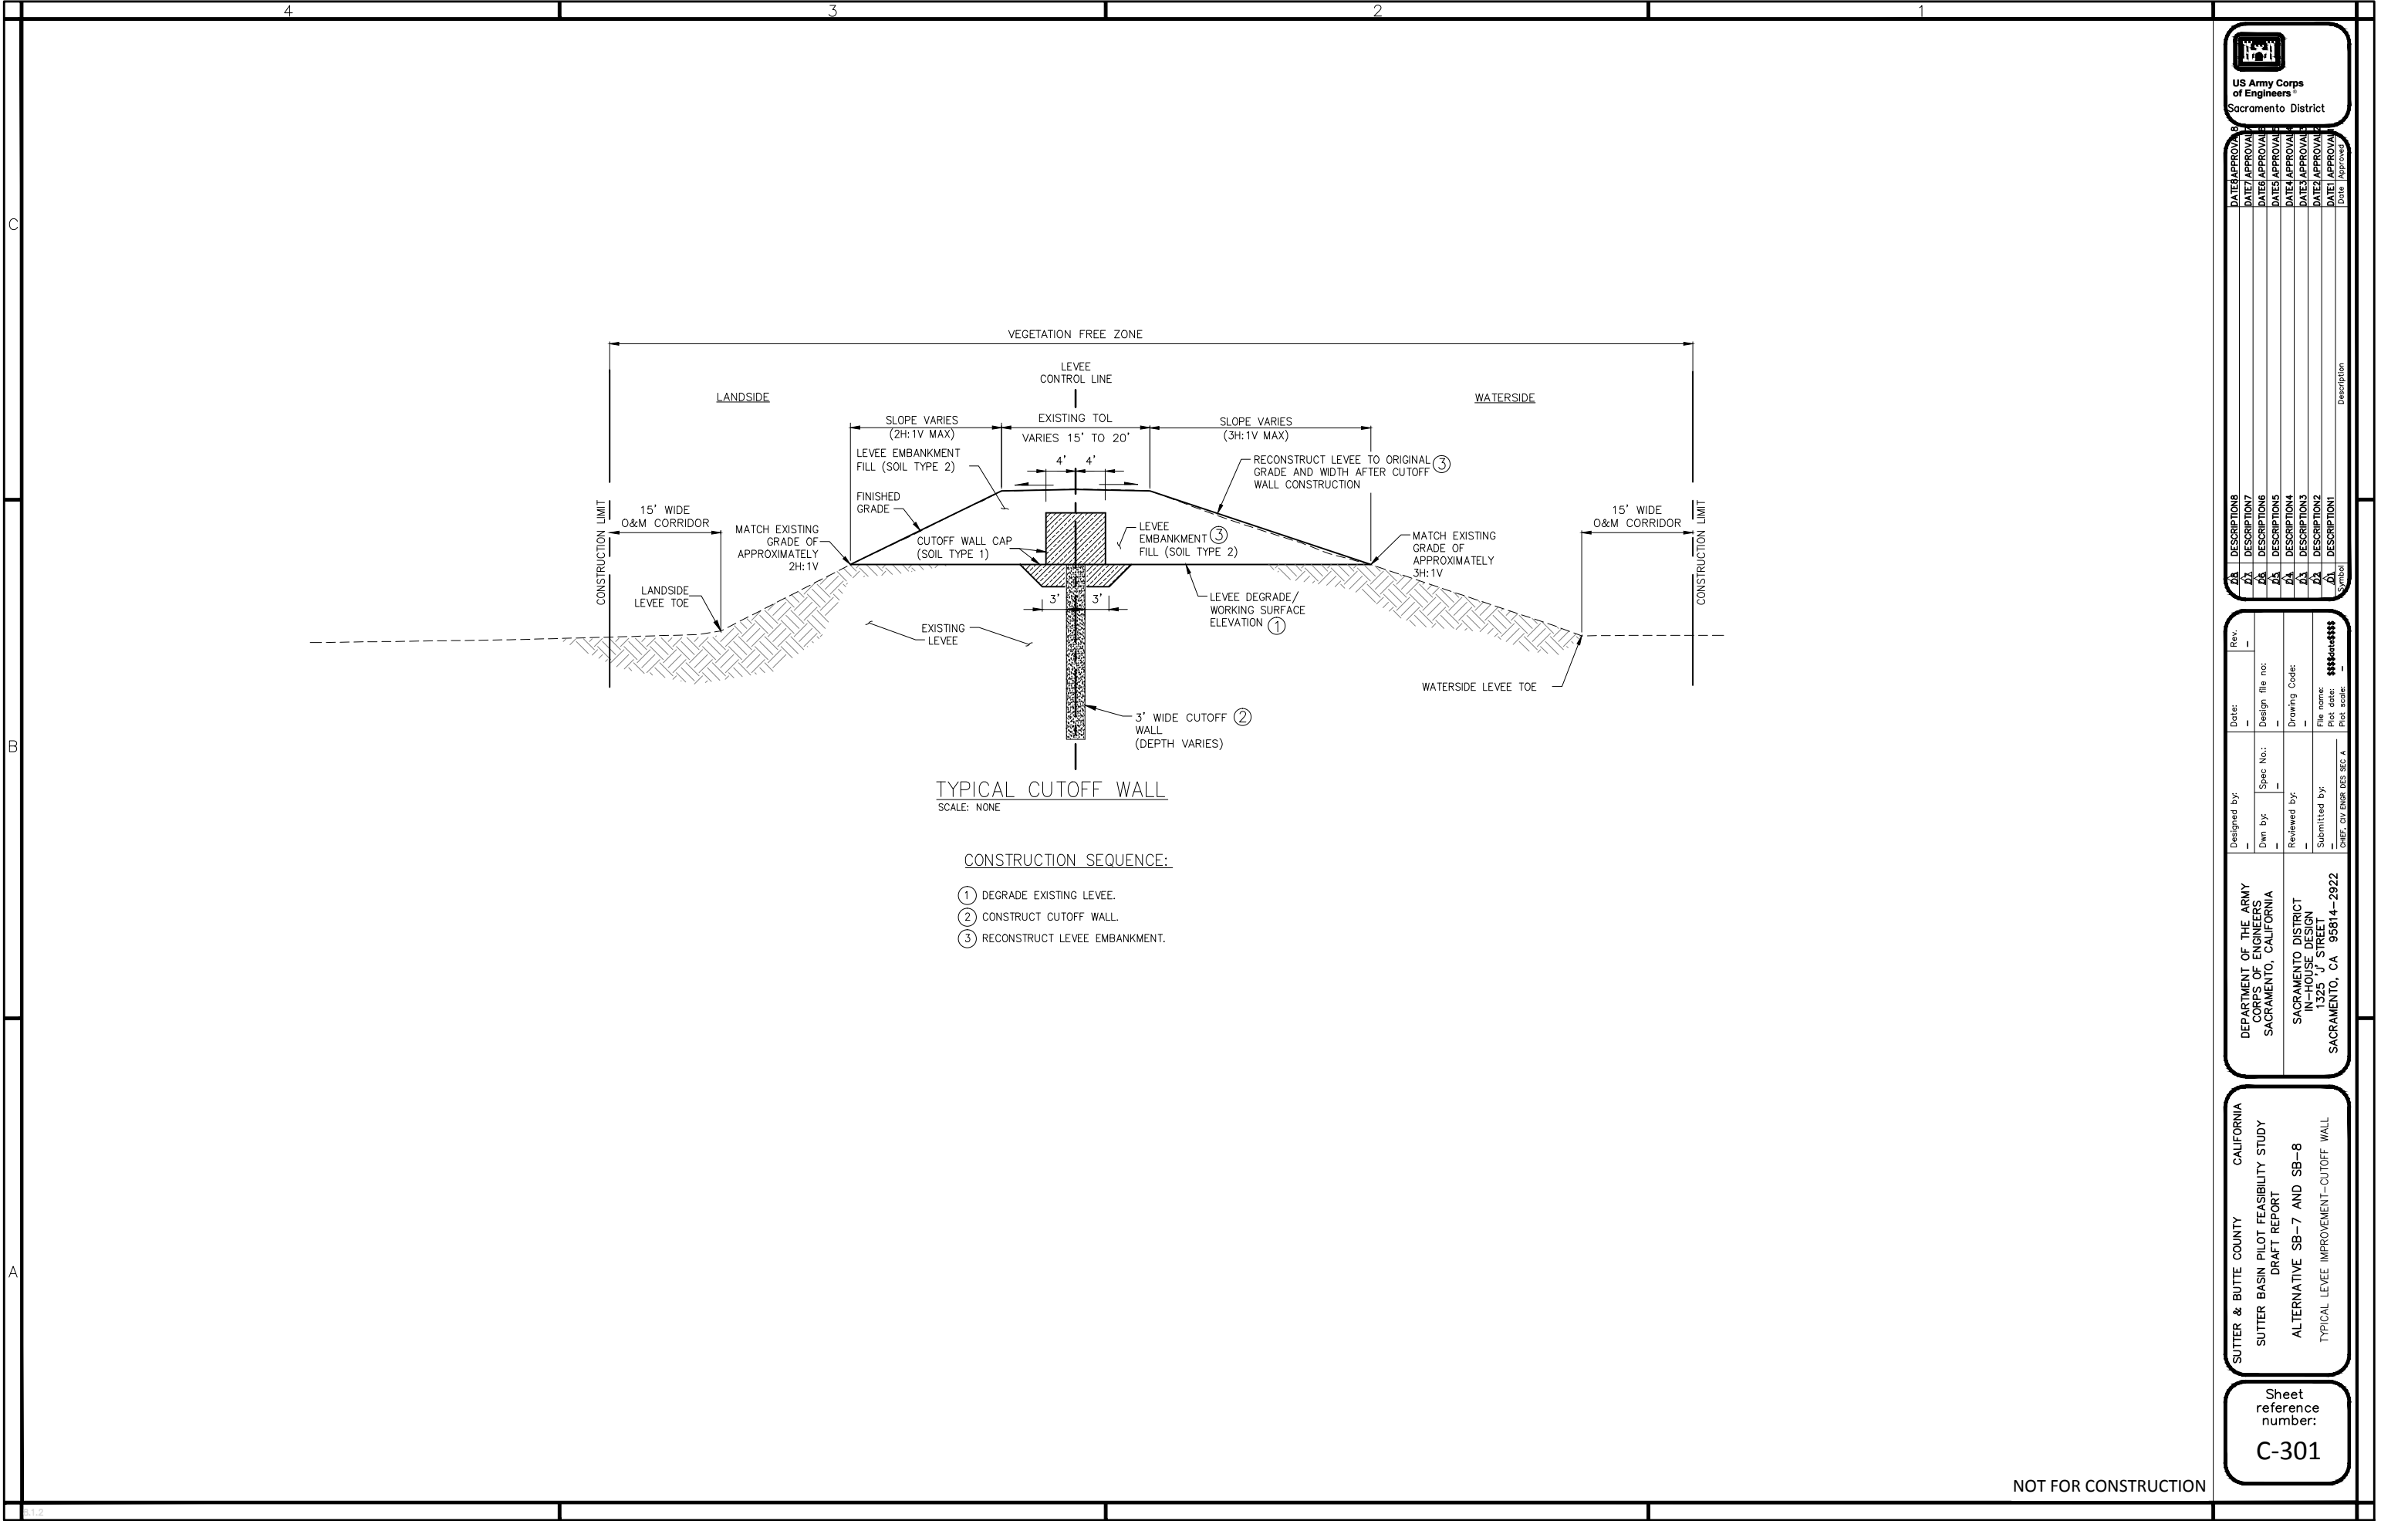

DATE/DESCRIPTION	DATE/DESCRIPTION	DATE/DESCRIPTION	DATE/DESCRIPTION	DATE/DESCRIPTION	DATE/DESCRIPTION	DATE/DESCRIPTION	DATE/DESCRIPTION	DATE/DESCRIPTION	DATE/DESCRIPTION
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DESIGNED BY	DATE	REV.	DESIGNED BY	DATE	REV.
DWN BY	DESIGN FILE NO.		DWN BY	DESIGN FILE NO.	
REVIEWED BY	SPEC NO.		REVIEWED BY	SPEC NO.	
SUBMITTED BY	DRAWING CODE		SUBMITTED BY	DRAWING CODE	
CHIEF, CIVIL ENGINEER	FILE NAME		CHIEF, CIVIL ENGINEER	FILE NAME	
	FILE DATE			FILE DATE	
	FILE SCALE			FILE SCALE	

SUTTER & BUTTE COUNTY	CALIFORNIA
SUTTER BASIN PILOT FEASIBILITY STUDY	
DRAFT REPORT	
ALTERNATIVE SB-7 AND SB-8	
TYPICAL LEVEE IMPROVEMENT-CUTOFF WALL	

Sheet reference number:
C-301

NOT FOR CONSTRUCTION



CONSTRUCTION SEQUENCE:

- 
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Sacramento District

Designed by:	Date:	Rev.
Dwn by:	Design file no:	
Reviewed by:	Drawing Code:	
Submitted by:	File name:	\$\$\$\$\$-date\$\$\$\$\$
CHEF, CIV INGR DES SEC A	Plot date:	
	Plot scale:	—

DEPARTMENT OF THE ARMY
CORPS OF ENGINEERS
SACRAMENTO, CALIFORNIA

SACRAMENTO DISTRICT
IN-HOUSE DESIGN
1325 'J' STREET
SACRAMENTO, CA 95814-2922


SUTTER & BUTTE COUNTY CALIFORNIA
SUTTER BASIN PILOT FEASIBILITY STUDY
DRAFT REPORT
ALTERNATIVE SB-7 AND SB-8
TYPICAL LEVEE IMPROVEMENT – CUTOFF WALL
WITH LEVEE RELOCATION

Sheet
reference
number:
C-305

C

B

A

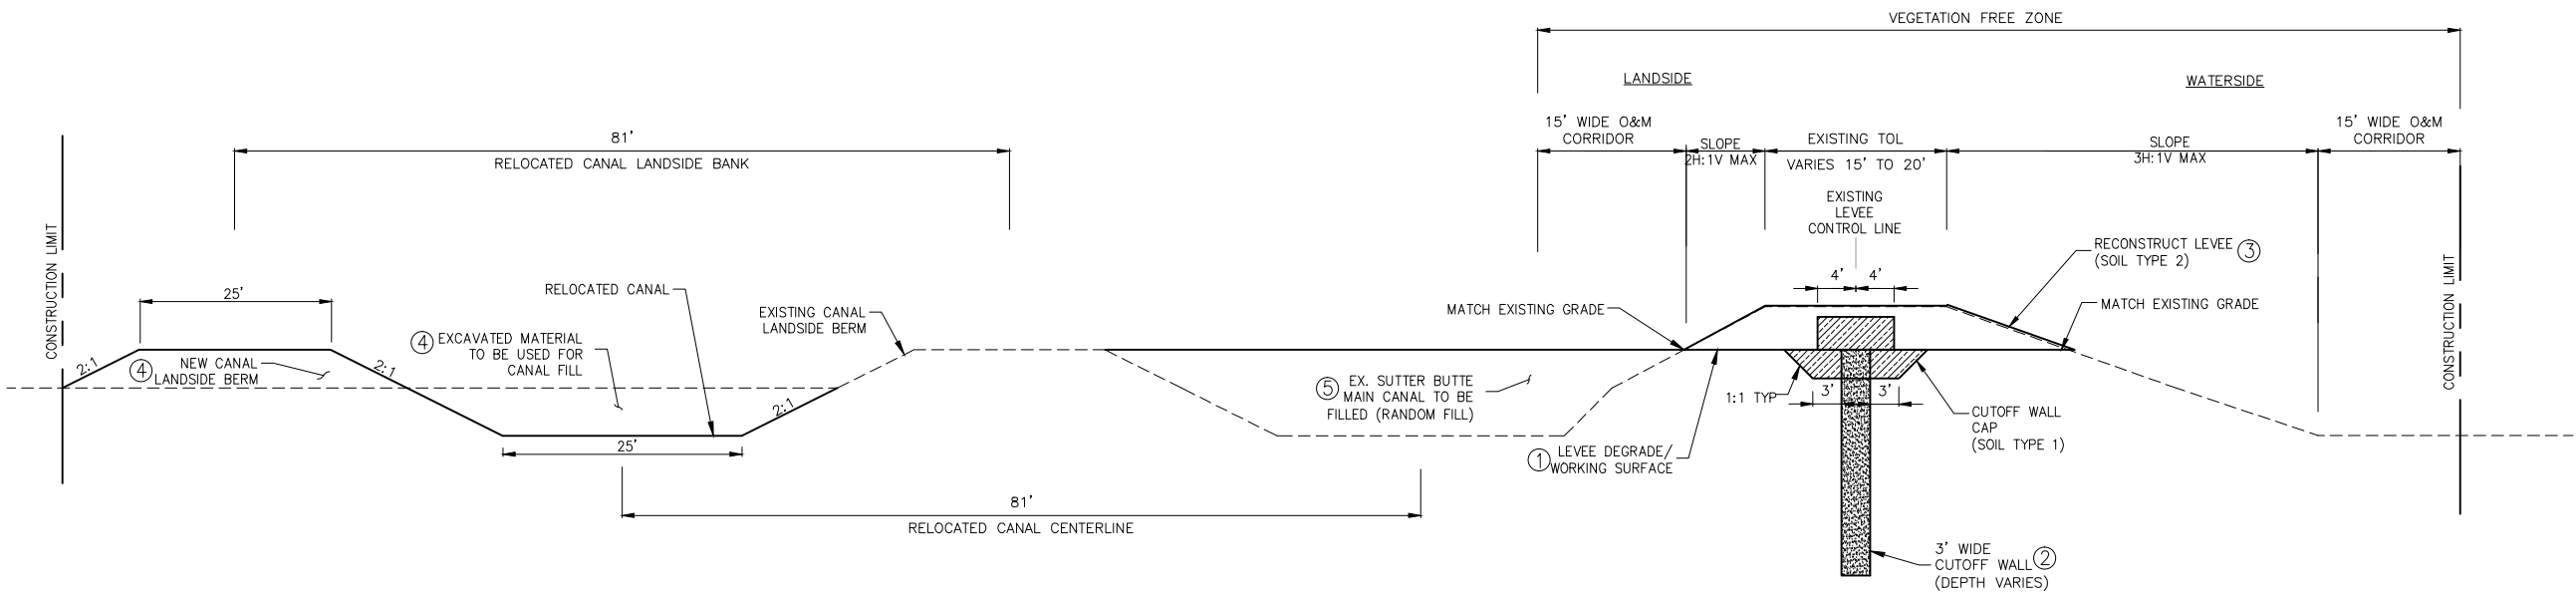

TYPICAL CUTOFF WALL WITH CANAL RELOCATION
SCALE: NONE

CONSTRUCTION SEQUENCE:

- 1 DEGRADE EXISTING LEVEE.
- 2 CONSTRUCT CUTOFF WALL.
- 3 RECONSTRUCT LEVEE EMBANKMENT.
- 4 EXCAVATE NEW SUTTER BUTTE CANAL AND CONSTRUCT NEW CANAL LANDSIDE BERM.
- 5 FILL SUTTER BUTTE CANAL WITH EXCAVATED MATERIAL.



US Army Corps
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Sacramento District

DATE	APPROVAL	DATE	APPROVAL	DATE	APPROVAL	DATE	APPROVAL	DATE	APPROVAL	DATE	APPROVAL	DATE	APPROVAL	DATE	APPROVAL
1	DESCRIPTION1	2	DESCRIPTION2	3	DESCRIPTION3	4	DESCRIPTION4	5	DESCRIPTION5	6	DESCRIPTION6	7	DESCRIPTION7	8	DESCRIPTION8

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DEPARTMENT OF THE ARMY CORPS OF ENGINEERS SACRAMENTO, CALIFORNIA	SACRAMENTO DISTRICT IN-HOUSE DESIGN 1325 J STREET SACRAMENTO, CA 95814-2922
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SUTTER & BUTTE COUNTY SUTTER BASIN PILOT FEASIBILITY STUDY DRAFT REPORT	CALIFORNIA ALTERNATIVE SB-7 AND SB-8 TYPICAL LEVEE IMPROVEMENT - CUTOFF WALL WITH CANAL RELOCATION
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Sheet
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number:


C-306

NOT FOR CONSTRUCTION

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B


A

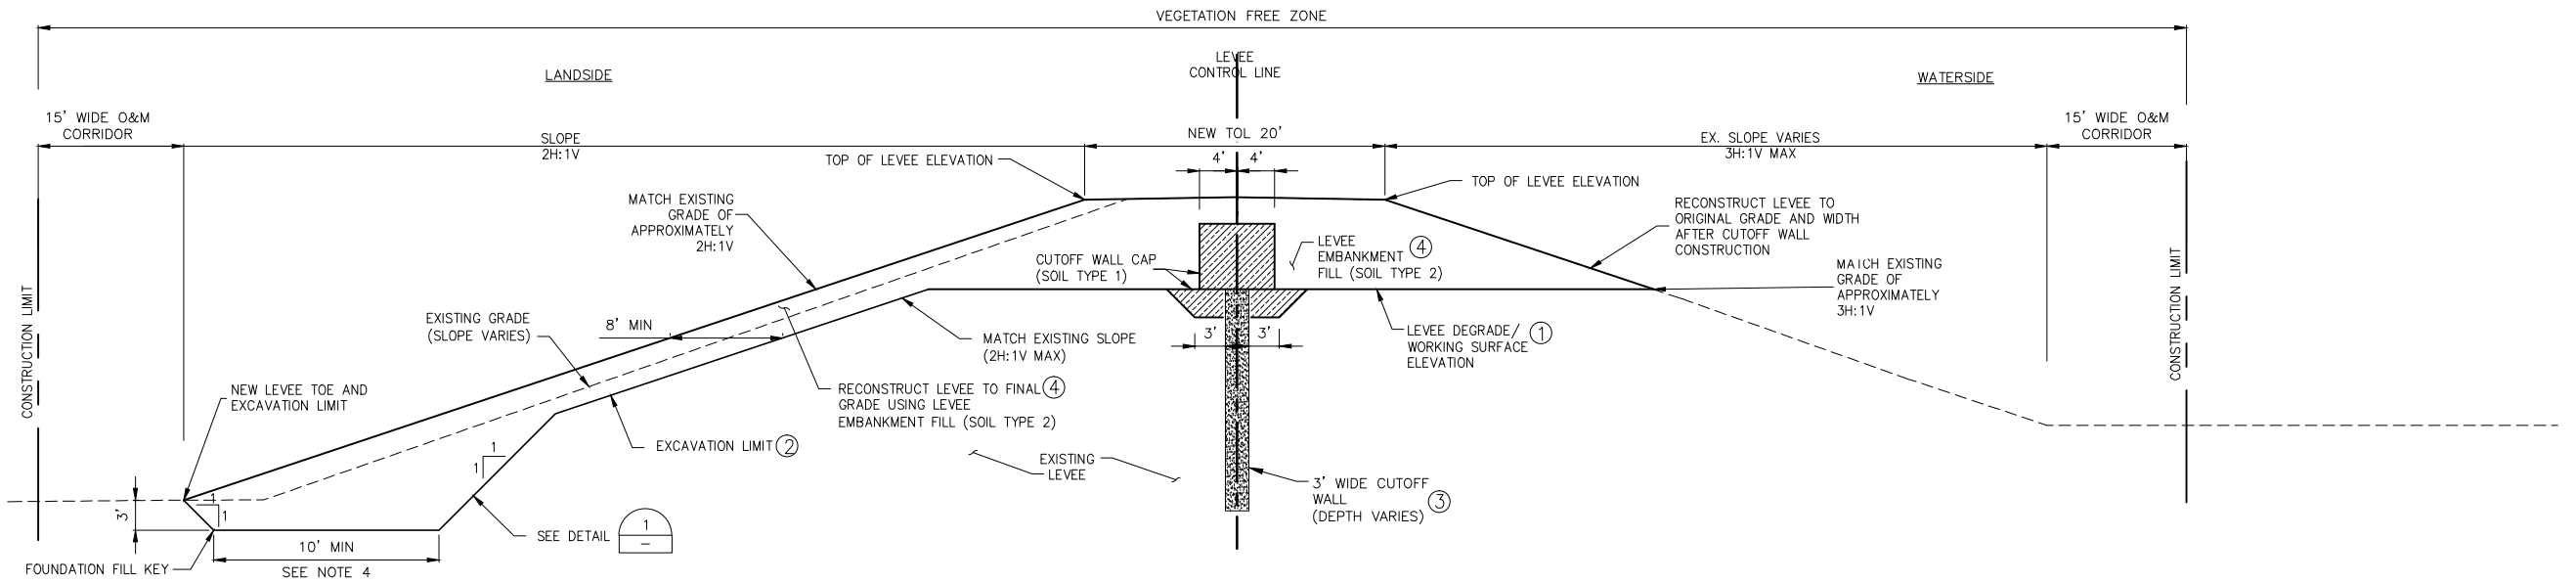

TYPICAL CUTOFF WALL WITH LANDSIDE TOE FILL
SCALE: NONE

CONSTRUCTION SEQUENCE:

- 1 DEGRADE EXISTING LEVEE.
- 2 EXCAVATE LANDSIDE OF EXISTING LEVEE.
- 3 CONSTRUCT CUTOFF WALL.
- 4 RECONSTRUCT LEVEE EMBANKMENT.

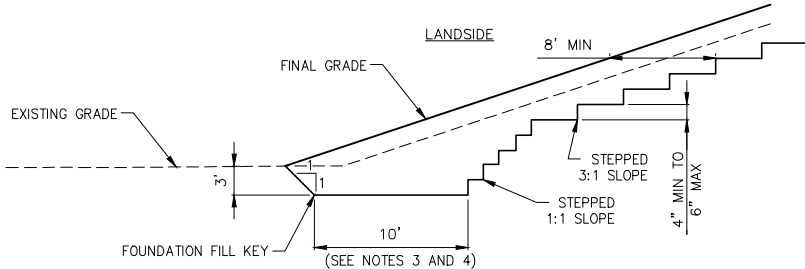

FILL KEY AND BENCHING DETAIL
NTS

TYPICAL KEY & BENCHING NOTES:

1. PLACE FILL IN HORIZONTAL LIFTS AGAINST VERTICAL FACES CUT INTO EXISTING LEVEE MATERIAL.
2. THE BOTTOM OF THE KEY TRENCH SHALL BE SCARIFIED TO A DEPTH OF 8 INCHES AND RECOMPACTED TO 95% MAXIMUM DENSITY PER ASTM D698.
3. THE LEVEE KEY TRENCH SHALL BE INSPECTED BY THE AGENCY'S GEOTECHNICAL ENGINEER BEFORE PLACEMENT OF FILL.
4. WHERE EMBANKMENT FILL IS GREATER THAN 10' IN WIDTH, FOUNDATION KEY SHALL EXTEND FROM THE TOE OF THE NEW LEVEE TO THE TOE OF THE EXISTING LEVEE. IN NO CASE SHALL THE FOUNDATION KEY WIDTH BE LESS THAN 10'.



US Army Corps
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Sacramento District

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DATE 1	APPROVAL	DESCRIPTION 1
DATE 2	APPROVAL	DESCRIPTION 2
DATE 3	APPROVAL	DESCRIPTION 3
DATE 4	APPROVAL	DESCRIPTION 4
DATE 5	APPROVAL	DESCRIPTION 5
DATE 6	APPROVAL	DESCRIPTION 6
DATE 7	APPROVAL	DESCRIPTION 7
DATE 8	APPROVAL	DESCRIPTION 8

Rev.	Date	Designed by	Spec No.	Design file no.	Drawing Code	Submitted by	Reviewed by	Plat date	Plat scale
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DEPARTMENT OF THE ARMY
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SACRAMENTO, CALIFORNIA


SACRAMENTO DISTRICT
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1325 J STREET
SACRAMENTO, CA 95814-2922

SUTTER & BUTTE COUNTY	CALIFORNIA
SUTTER BASIN PILOT FEASIBILITY STUDY DRAFT REPORT	ALTERNATIVE SB-7 AND SB-8
TYPICAL LEVEE IMPROVEMENT - TYPICAL CUTOFF WALL WITH LANDSIDE TOE FILL	

Sheet
reference
number:

C-307

NOT FOR CONSTRUCTION

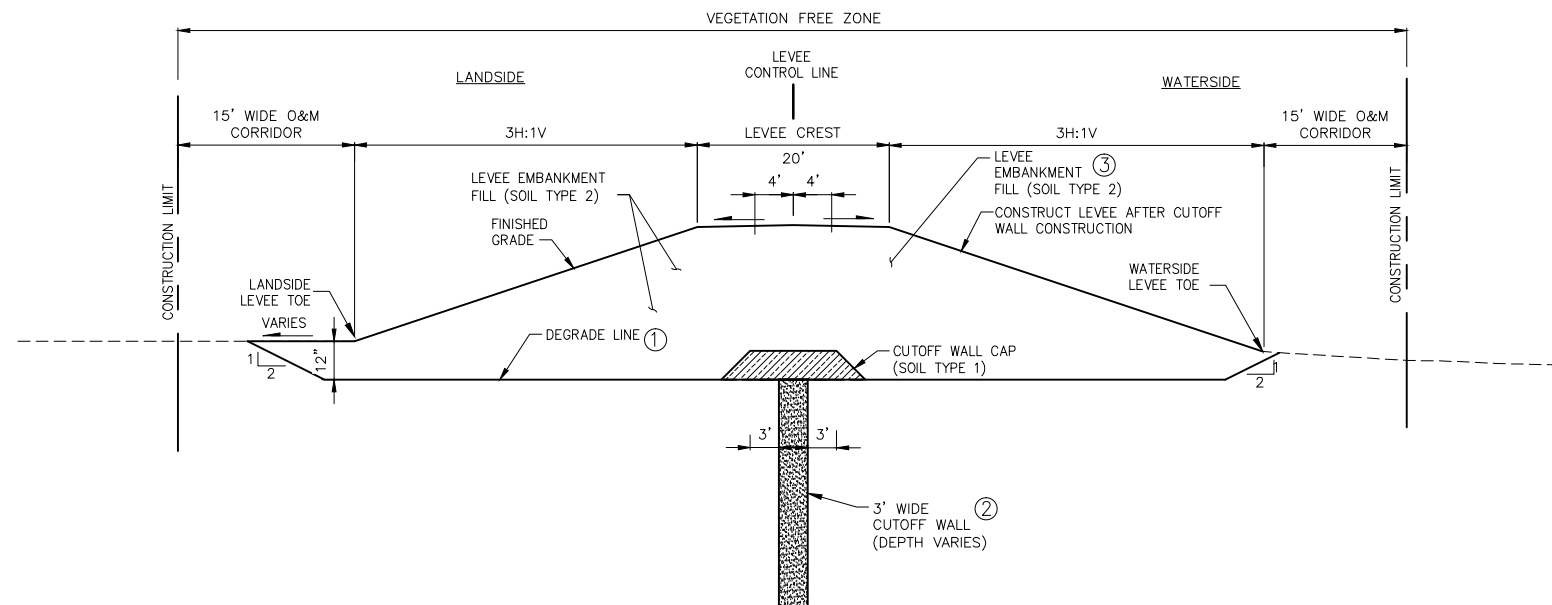

TYPICAL NEW LEVEE WITH CUTOFF WALL
SCALE: NONE

CONSTRUCTION SEQUENCE:

- ① EXCAVATE TO DEGRADE LINE
- ② CONSTRUCT CUTOFF WALL.
- ③ CONSTRUCT LEVEE EMBANKMENT.

NOT FOR CONSTRUCTION

Sheet
reference
number:
C-308

SUTTER & BUTTE COUNTY CALIFORNIA
SUTTER BASIN PILOT FEASIBILITY STUDY
DRAFT REPORT
ALTERNATIVE SB-7 AND SB-8
TYPICAL LEVEE IMPROVEMENT – NEW LEVEE WITH
CUTOFF WALL


DEPARTMENT OF THE ARMY
CORPS OF ENGINEERS
SACRAMENTO, CALIFORNIA

SACRAMENTO DISTRICT
IN-HOUSE DESIGN
1325 'J' STREET
SACRAMENTO, CA 95814-2922


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06	DESCRIPTION6	DATE6 APPROVAL
07	DESCRIPTION7	DATE7 APPROVAL
08	DESCRIPTION8	DATE8 APPROVAL



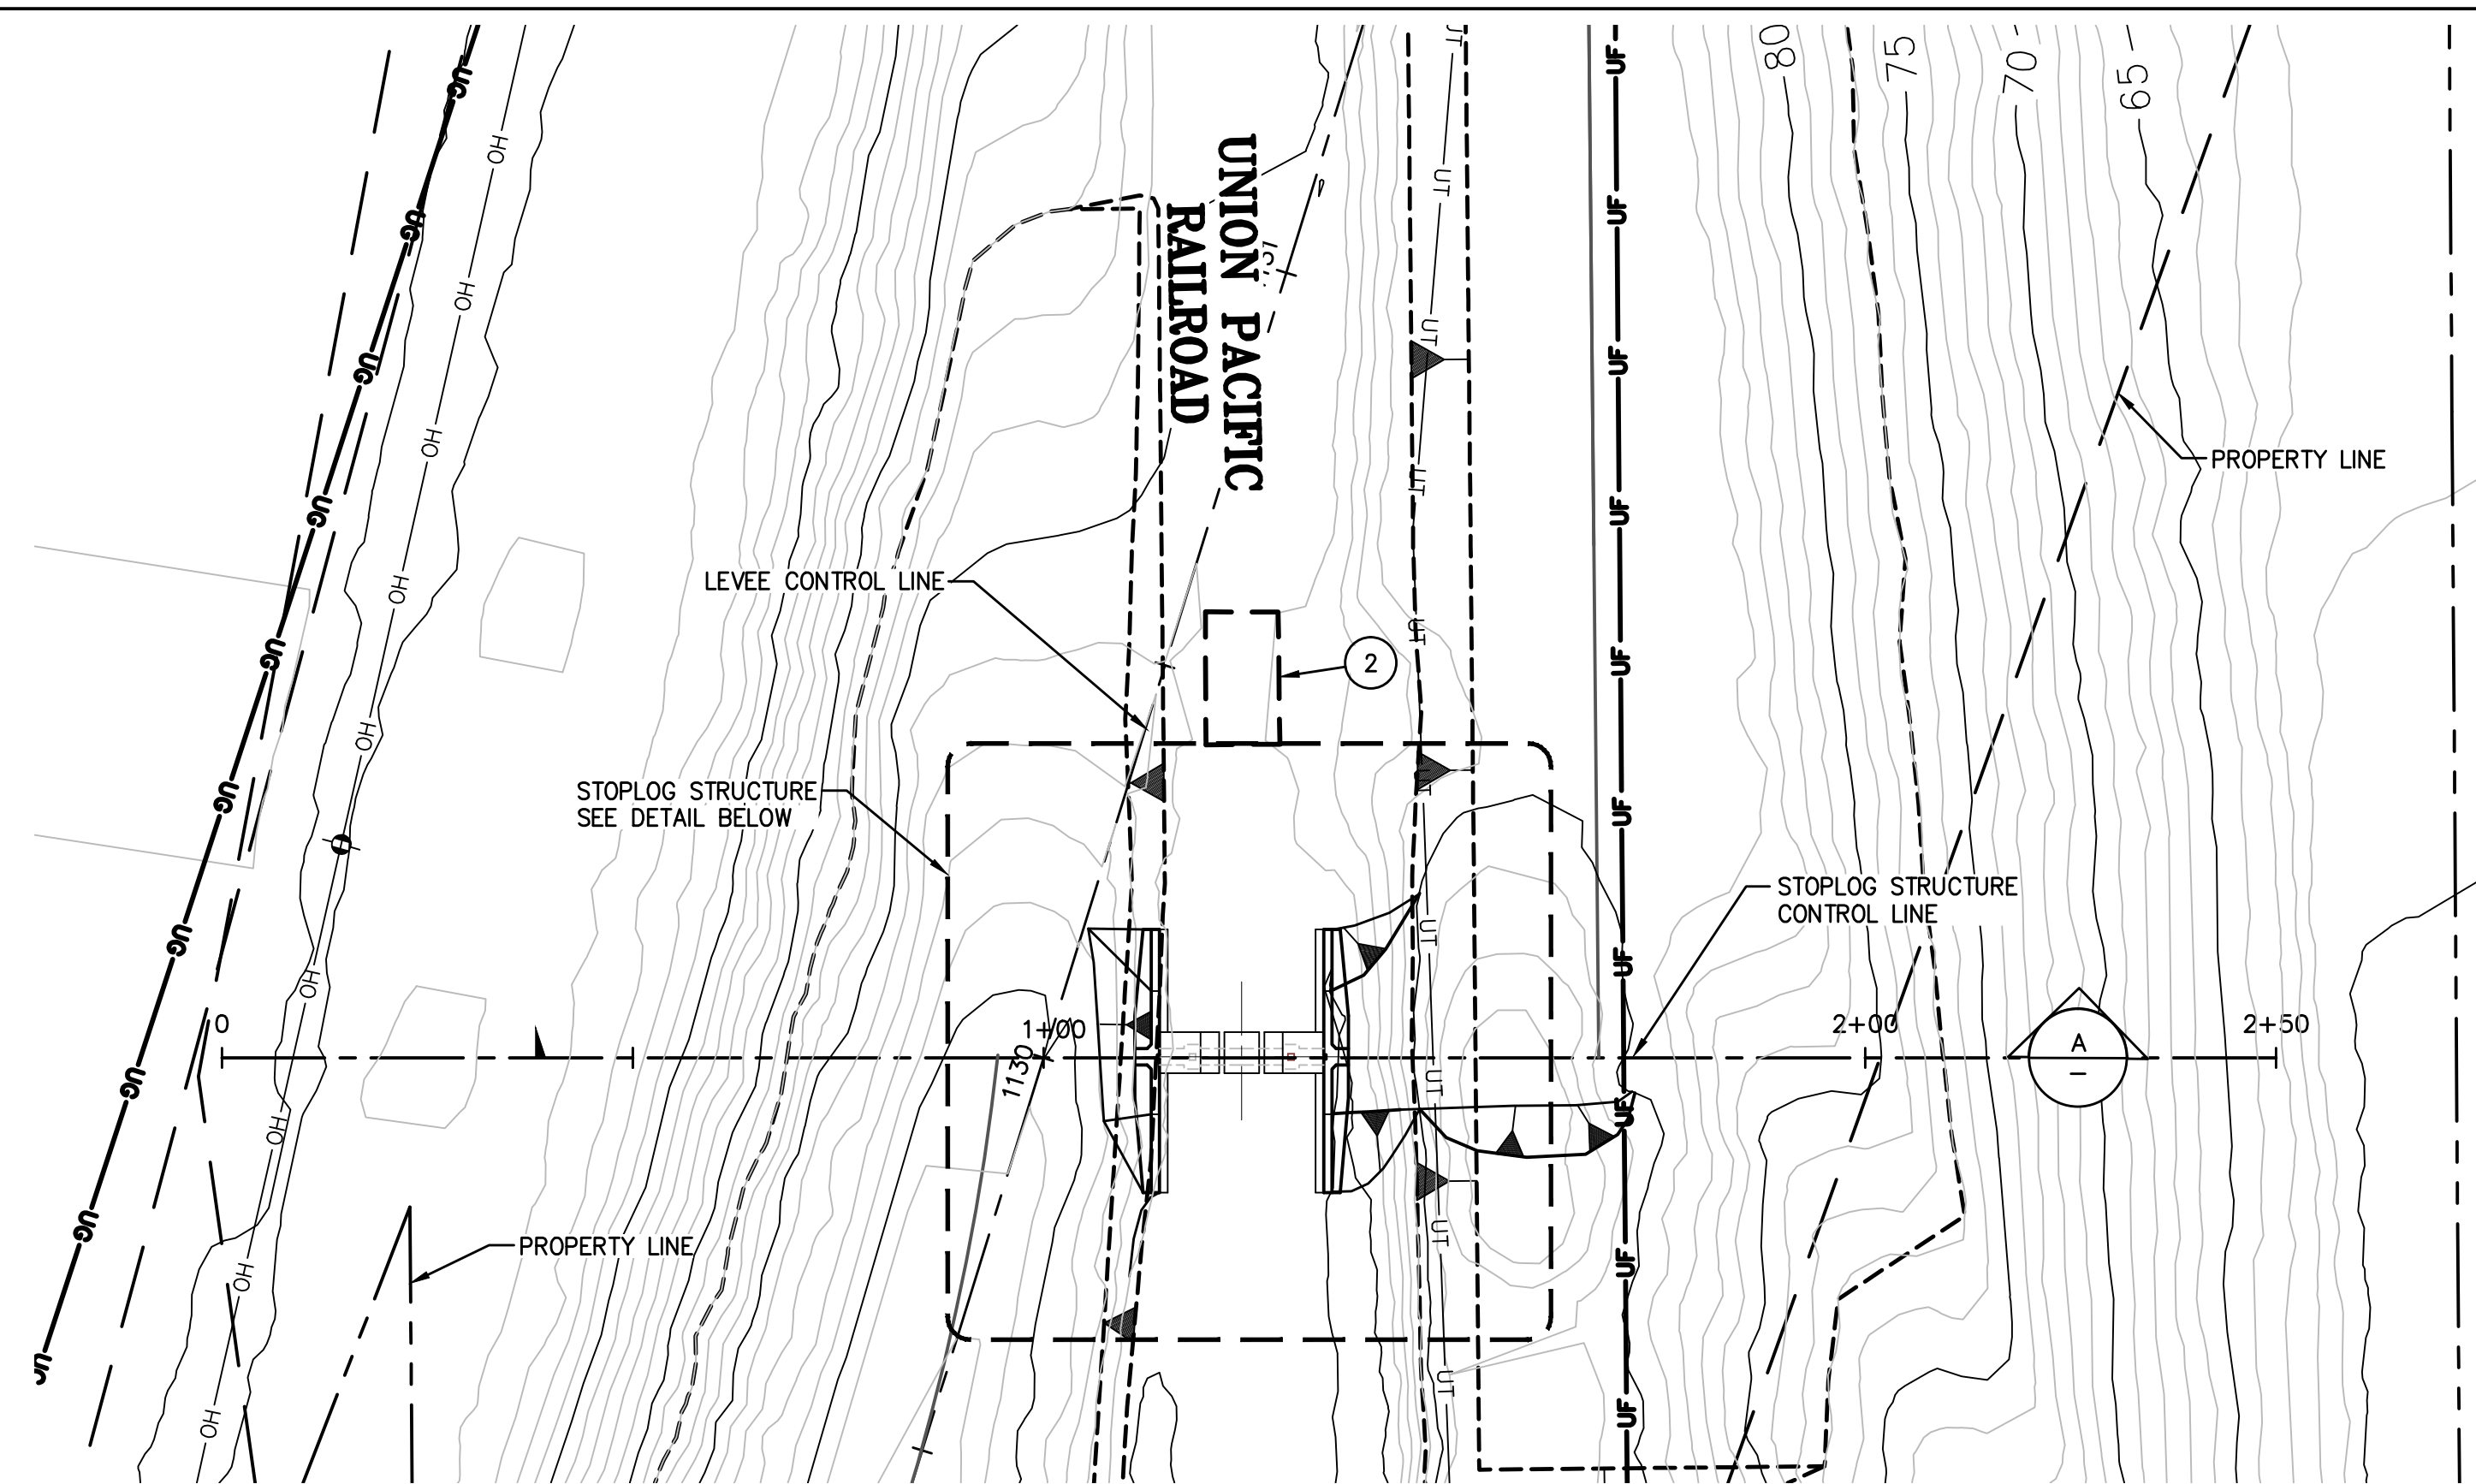

STOPLOG STRUCTURE – PLAN

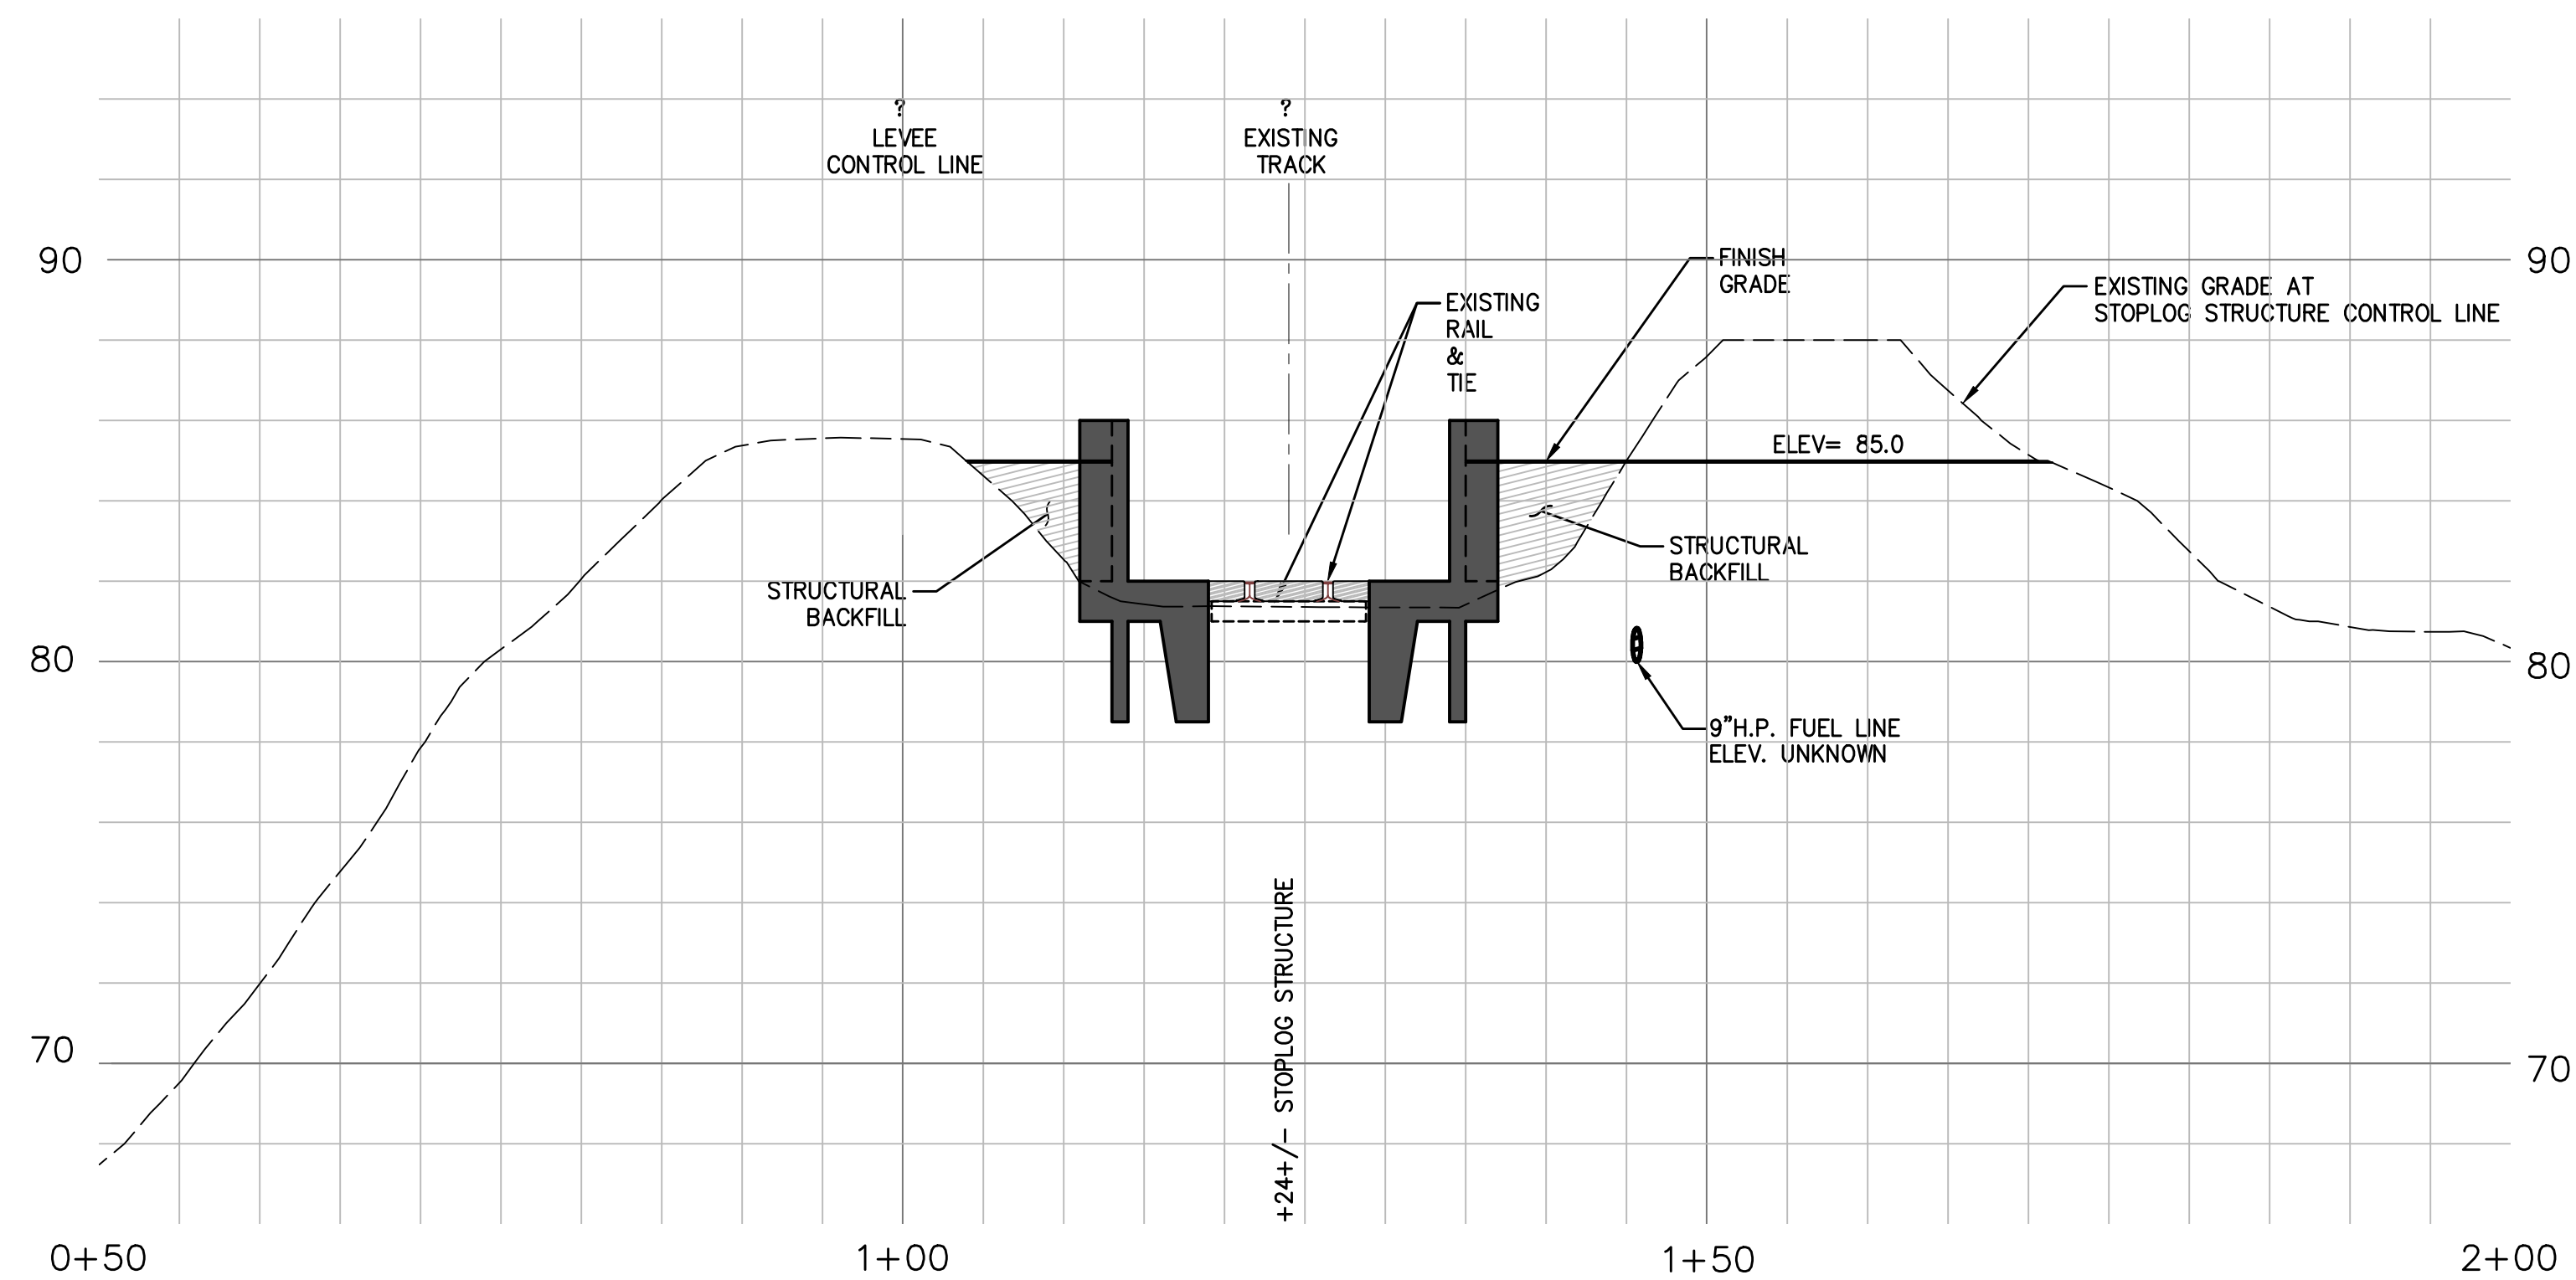

STOPLOG STRUCTURE – ELEVATION

CONSTRUCTION NOTES:

- ① CUTOFF WALL AND LEVEE DEGRADE NOT SHOWN, SEE DWG C-314 FOR WALL LOCATION AND LEVEE EXCAVATIONS.
- ② EXISTING CONCRETE PANELS TO REMAIN.



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D2	DESCRIPTION2	DATE2	APPROVAL2
D3	DESCRIPTION3	DATE3	APPROVAL3
D4	DESCRIPTION4	DATE4	APPROVAL4
D5	DESCRIPTION5	DATE5	APPROVAL5
D6	DESCRIPTION6	DATE6	APPROVAL6
D7	DESCRIPTION7	DATE7	APPROVAL7
D8	DESCRIPTION8	DATE8	APPROVAL8

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SACRAMENTO, CALIFORNIA


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1325 'J' STREET
SACRAMENTO, CA 95814-2922

WATER & BUTTE COUNTY CALIFORNIA
SUTTER BASIN PILOT FEASIBILITY STUDY
DRAFT REPORT
ALTERNATIVE SB-7 AND SB-8
TYPICAL LEVEE IMPROVEMENT - STOP LOG
STRUCTURE

Sheet
reference
number:

C-310

NOT FOR CONSTRUCTION

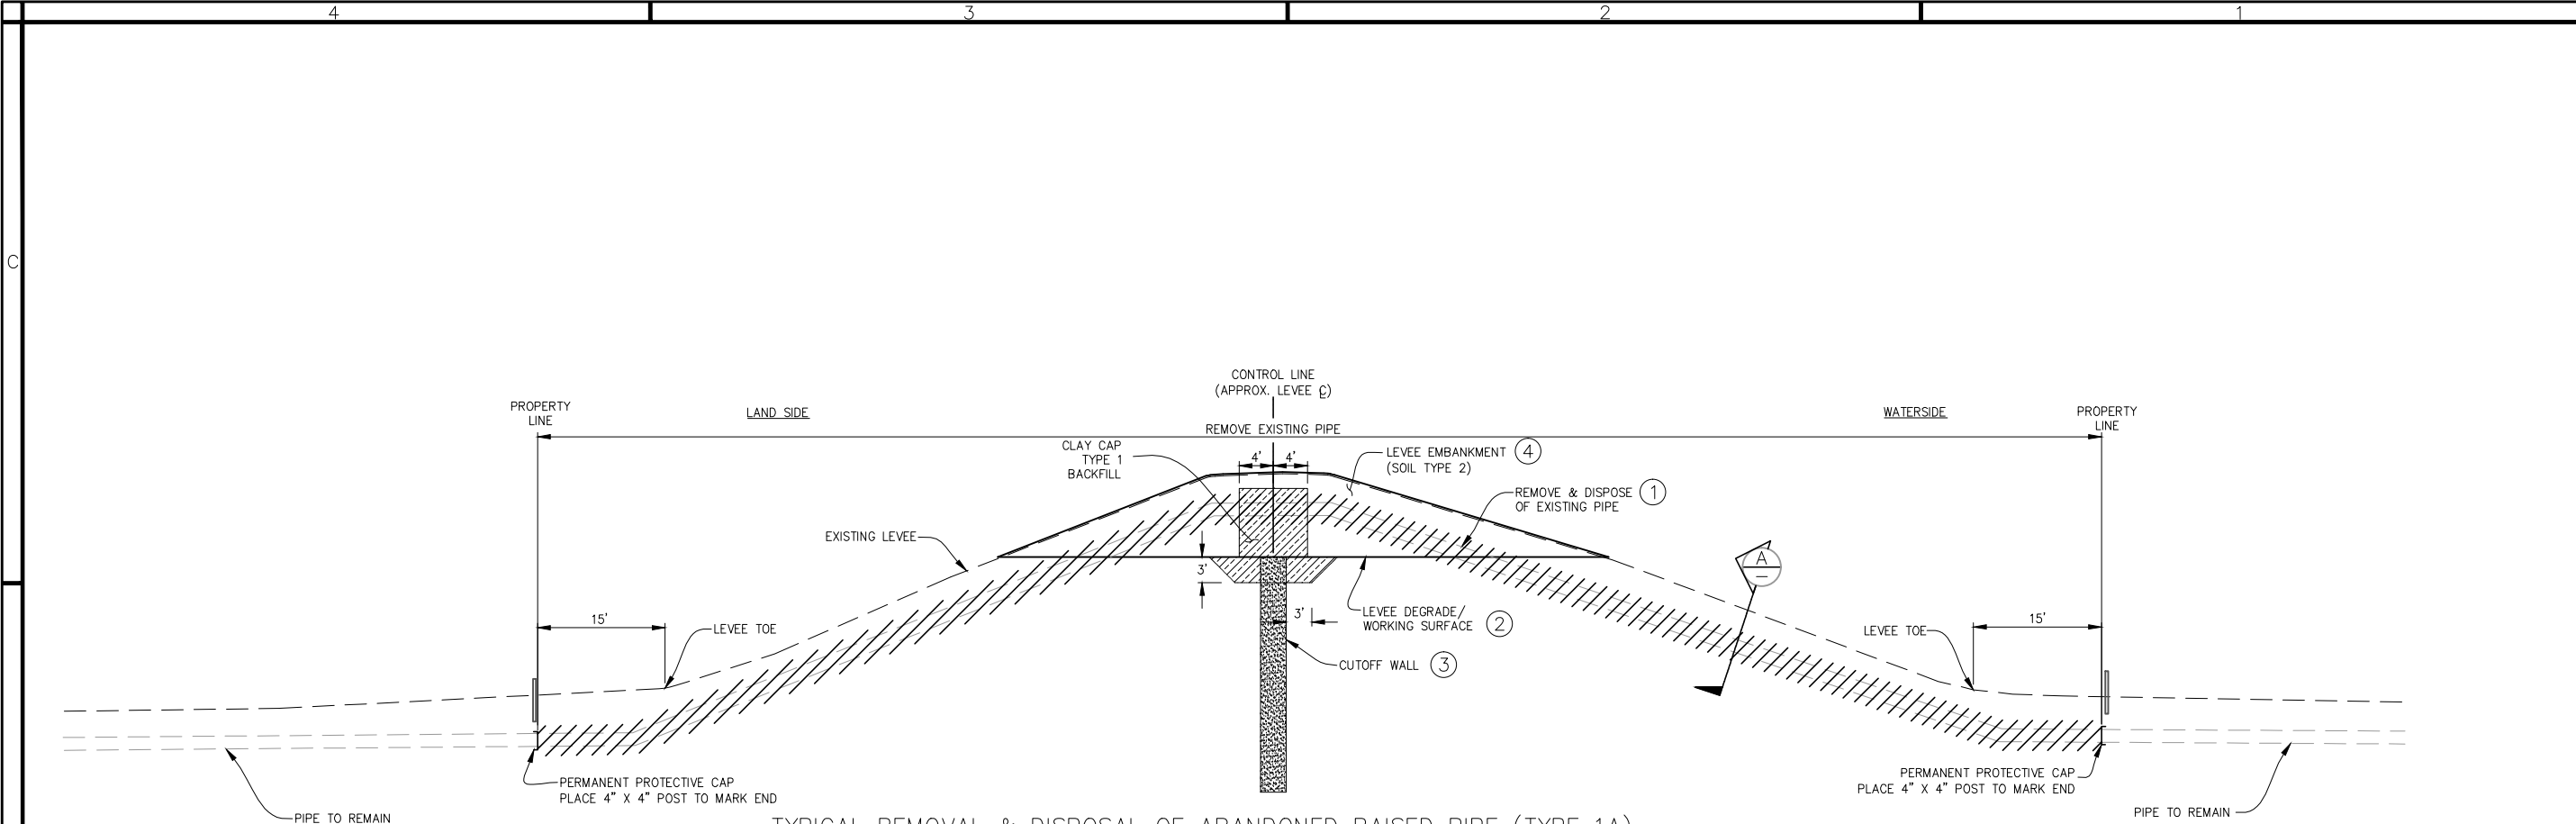


TYPICAL REMOVAL & DISPOSAL OF ABANDONED RAISED PIPE (TYPE 1A)

SCALE: NONE

CONSTRUCTION SEQUENCE:

- 1 EXCAVATE, REMOVE AND DISPOSE OF EXISTING PIPE OFFSITE, AND BACKFILL UP TO WORKING SURFACE.
- 2 DEGRADE EXISTING LEVEE.
- 3 CONSTRUCT CUTOFF WALL.
- 4 RECONSTRUCT LEVEE EMBANKMENT.

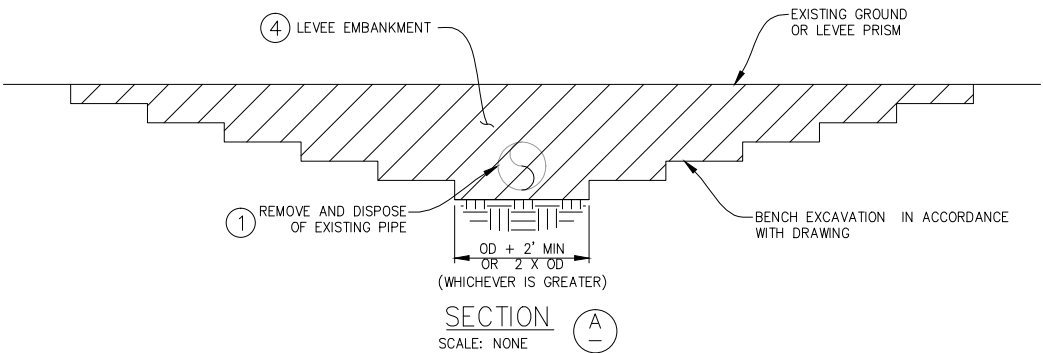

SCHEDULE OF RAISED PIPE REMOVALS		
EXISTING STATION	EXISTING PIPE DIA.	APPROX. DEPTH
219+00	12 IN	UNKNOWN
365+00	8 IN	4.8 FT
386+63	8 IN	4.6 FT
396+32	8 IN	4.1 FT
442+80	8 IN	4.1 FT
460+11	8 IN	4.1 FT
529+47	6 IN	4.0 FT
536+64	5 IN	2.0 FT
545+41	8 IN	3.1 FT
856+23	24 IN	5.2 FT
881+39	6 IN	5.1 FT
881+43	14 IN	5.1 FT
988+05	3 IN	UNKNOWN
1020+85	4 IN	UNKNOWN
1037+50	8 IN	UNKNOWN
1180+50	12 IN	UNKNOWN
1180+98	3 IN	UNKNOWN
1181+50	8 IN	UNKNOWN
1524+35	6 IN	UNKNOWN
1532+40	6 IN	UNKNOWN
1888+50	6 IN	5.2 FT
1893+60	1 IN	UNKNOWN

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Sacramento District

DATE 1 APPROVAL	DATE 2 APPROVAL	DATE 3 APPROVAL	DATE 4 APPROVAL	DATE 5 APPROVAL	DATE 6 APPROVAL	DATE 7 APPROVAL	DATE 8 APPROVAL
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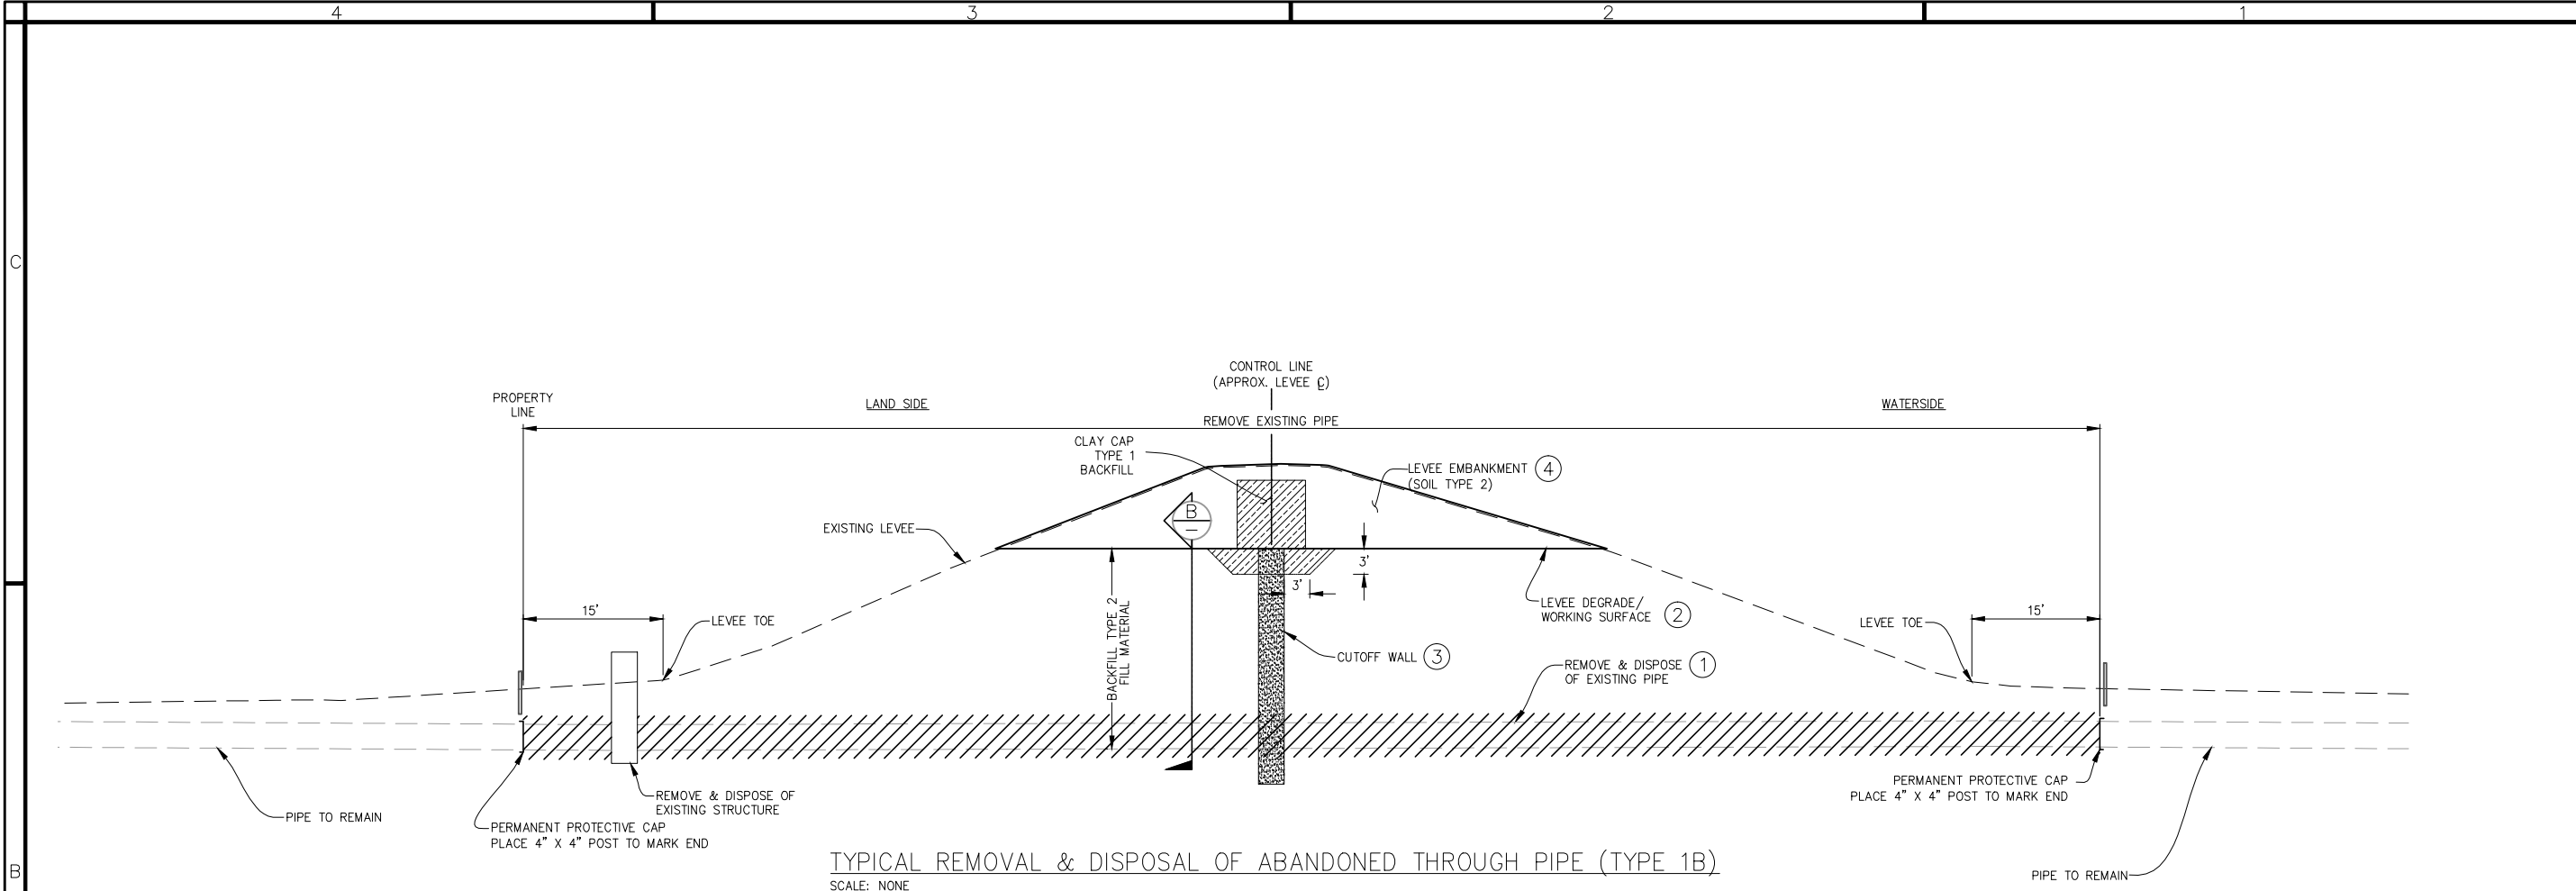
DEPARTMENT OF THE ARMY
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SACRAMENTO, CALIFORNIA

SACRAMENTO DISTRICT
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1325 J STREET
SACRAMENTO, CA 95814-2922

SUTTER & BUTTE COUNTY CALIFORNIA
SUTTER BASIN PILOT FEASIBILITY STUDY
DRAFT REPORT


ALTERNATIVE SB-7 AND SB-8
TYPICAL UTILITY IMPROVEMENT - REMOVAL AND DISPOSAL OF ABANDONED RAISED PIPE

Sheet reference number:
C-401



TYPICAL REMOVAL & DISPOSAL OF ABANDONED THROUGH PIPE (TYPE 1B)
SCALE: NONE

- CONSTRUCTION SEQUENCE:
- 1 EXCAVATE, REMOVE AND DISPOSE OF EXISTING PIPE OFFSITE, AND BACKFILL UP TO WORKING SURFACE.
 - 2 DEGRADE EXISTING LEVEE.
 - 3 CONSTRUCT CUTOFF WALL.
 - 4 RECONSTRUCT LEVEE EMBANKMENT.

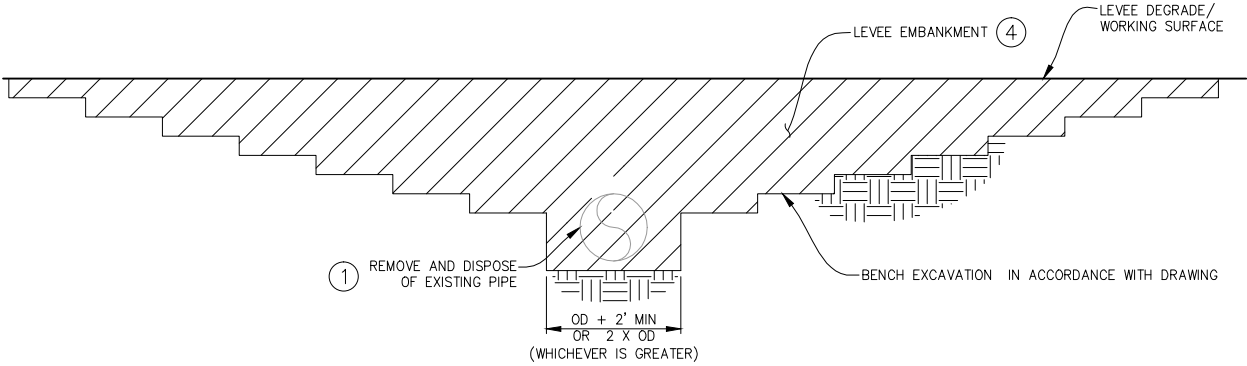

SECTION B-B
SCALE: NONE

SCHEDULE OF THROUGH PIPE REMOVALS		
EXISTING STATION	EXISTING PIPE DIA.	APPROX. DEPTH
298+89	36 IN	UNKNOWN
407+72	8 IN	21.8 FT
1043+52	27 IN	38.6 FT
1556+22	8 IN	UNKNOWN
1585+05	12 IN	UNKNOWN
1785+55	24 IN	UNKNOWN
1813+70	24 IN	UNKNOWN
1868+17	18 IN	UNKNOWN
2026+40	12 IN	13.5 FT
2032+90	12 IN	14.0 FT
2201+87	10 IN	13.1 FT
2268+27	24 IN	18.4 FT
2312+05	24 IN	UNKNOWN
2352+80	24 IN	UNKNOWN




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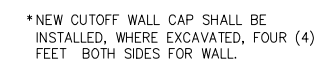


CONSTRUCTION SEQUENCE:

- ① EXCAVATE, REMOVE AND DISPOSE OF EXISTING PIPE OFFSITE, AND BACKFILL UP TO DEGRADE / WORKING SURFACE.
- ② PROVIDE CAP AND MARKER AT THE END OF THE EXISTING PIPE WITH PROPER THRUST BLOCK OR RESTRAINED JOINT FOR PRESSURIZED PIPES.
- ③ DEGRADE EXISTING LEVEE.
- ④ CONSTRUCT CUTOFF WALL.
- ⑤ RECONSTRUCT LEVEE EMBANKMENT.
- ⑥ EXCAVATE, INSTALL NEW PIPE, CONNECT TO EXISTING PIPE, INSTALL MARKER AND BACKFILL.

NOTE: THE BOTTOM OF THE NEW PIPE
SHALL BE ABOVE THE FREEBOARD
ELEVATION AT THE LEVEE CROWN

SCHEDULE OF RAISED PIPE REPLACEMENTS			
EXISTING STATION	EXISTING PIPE DIA.	APPROX. DEPTH	NEW PIPE DIA.
1043+22	24 IN	4.0 FT	24 IN
1043+27	24 IN	2.0 FT	24 IN
1043+45	36 IN	5.0 FT	36 IN
1073+41	12 IN	UNKNOWN	12 IN
1079+91	8 IN	UNKNOWN	8 IN
1096+50	48 IN	N/A	48 IN
1096+62	42 IN	2.5 FT	42 IN
1096+71	24 IN	4.7 FT	24 IN
1096+81	28 IN	5.0 FT	30 IN
1111+46	16 IN	1.1 FT	16 IN
1127+48	10 IN	2.0 FT	10 IN
1131+82	CABLE	UNKNOWN	CABLE
1132+09	9 IN	UNKNOWN	9 IN
1135+31	16 IN	UNKNOWN	16 IN
1229+41	16 IN	3.0 FT	16 IN
1265+29	18 IN	UNKNOWN	18 IN
1314+80	20 IN	1.4 FT	20 IN
1347+00	CABLE	UNKNOWN	CABLE
1430+40	36 IN	15.6 FT	36 IN
1430+48	60 IN	15.6 FT	60 IN
1430+56	60 IN	15.6 FT	60 IN
1823+01	12 /24 IN	21.8 FT	12 IN
1834+42	12 /24 IN	15.4 FT	12 IN
1849+80	18 IN	2.8 FT	18 IN
2004+86	7 IN	14.0 FT	7 IN
2084+03	5 IN	14.0 FT	5 IN
2092+90	CABLE	UNKNOWN	CABLE
2127+33	2 IN	2.0 FT	2 IN
2248+30	CABLE	UNKNOWN	CABLE
2283+44	1 IN	UNKNOWN	1 IN
2283+44	8 /24IN	17.3 FT	8 IN
2345+79	10 IN	12.7 FT	10 IN

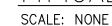

NOT FOR CONSTRUCTION

	Description	Date Approved
D8	DESCRIPTION8	DATE APPROVAL8
D7	DESCRIPTION7	DATE7 APPROVAL
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D5	DESCRIPTION5	DATE5 APPROVAL
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D3	DESCRIPTION3	DATE3 APPROVAL
D2	DESCRIPTION2	DATE2 APPROVAL
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DEPARTMENT OF THE ARMY
CORPS OF ENGINEERS
SACRAMENTO, CALIFORNIA

SACRAMENTO DISTRICT
IN-HOUSE DESIGN
1325 'J' STREET
SACRAMENTO, CA 95814-2922

JUTTER & BUTTE COUNTY CALIFORNIA
SUTTER BASIN PILOT FEASIBILITY STUDY
DRAFT REPORT
ALTERNATIVE SB-7 AND SB-8
TYPICAL UTILITY IMPROVEMENT – REMOVAL AND
REPLACEMENT OF RAISED PIPE

Sheet
reference
number:
C-403



- SECTION (F)
SCALE: NONE

SCHEDULE OF THROUGH PIPE REPLACEMENTS			
EXISTING STATION	EXISTING PIPE DIA.	APPROX. DEPTH RISER	NEW PIPE DIA.
1961+03	2-60 IN	24.6 FT	2-60 IN
2017+78	22 IN	18.3 FT	36 IN
2178+39	16 IN	16.8 FT	36 IN
2239+66	24 IN	18.6 FT	36 IN
2245+52	24 IN	18.2 FT	36 IN
2250+76	24 IN	21.7 FT	36 IN
2256+71	24 IN	24.0 FT	36 IN
2256+94	24 IN	18.4 FT	36 IN
2260+55	24 IN	20.0 FT	36 IN
2262+69	24 IN	24.6 FT	36 IN
2274+86	24 IN	24.8 FT	36 IN
2274+95	24 IN	24.5 FT	36 IN
2283+65	24 IN	17.3 FT	36 IN

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01/11/2023	DESCRIPTION7	DATE/APPROVAL
01/11/2023	DESCRIPTION6	DATE/APPROVAL
01/11/2023	DESCRIPTION5	DATE/APPROVAL
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UTTER & BUTTE COUNTY CALIFORNIA
SUTTER BASIN PILOT FEASIBILITY STUDY
DRAFT REPORT
ALTERNATIVE SB-7 AND SB-8
TYPICAL UTILITY IMPROVEMENT – REMOVAL AND




- ① DEGRADE EXISTING LEVEE.
- ② EXCAVATE, REMOVE AND DISPOSE OF EXISTING PIPE OFFSITE, AND BACKFILL UP TO WORKING SURFACE.
- ③ CONSTRUCT CUTOFF WALL.
- ④ EXCAVATE, INSTALL NEW PIPE AND BACKFILL UP TO WORKING SURFACE.
- ⑤ RECONSTRUCT LEVEE EMBANKMENT FOR AREA EXCAVATED FOR PIPE AND RISER INSTALLATION.
- ⑥ EXCAVATE NEW SUTTER BUTTE CANAL AND CONSTRUCT LANDSIDE BERM
- ⑦ BACKFILL OLD SUTTER BUTTE CANAL

DEPARTMENT OF THE ARMY CORPS OF ENGINEERS SACRAMENTO, CALIFORNIA	Designed by: _____	Date: _____	Rev. _____
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BUTTE COUNTY CALIFORNIA
 SUTTER BASIN PILOT FEASIBILITY STUDY
 DRAFT REPORT
 ALTERNATIVE SB-7 AND SB-8
 TYPICAL UTILITY IMPROVEMENT – REMOVAL AND
 REPLACEMENT OF THROUGH PIPE W/ CANAL
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Sheet
reference
number:
C-406

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US Army Corps of Engineers
Sacramento District

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DEPARTMENT OF THE ARMY CORPS OF ENGINEERS SACRAMENTO, CALIFORNIA				SACRAMENTO DISTRICT IN-HOUSE DESIGN 1325 J STREET SACRAMENTO, CA 95814-2922			

SUTTER & BUTTE COUNTY CALIFORNIA

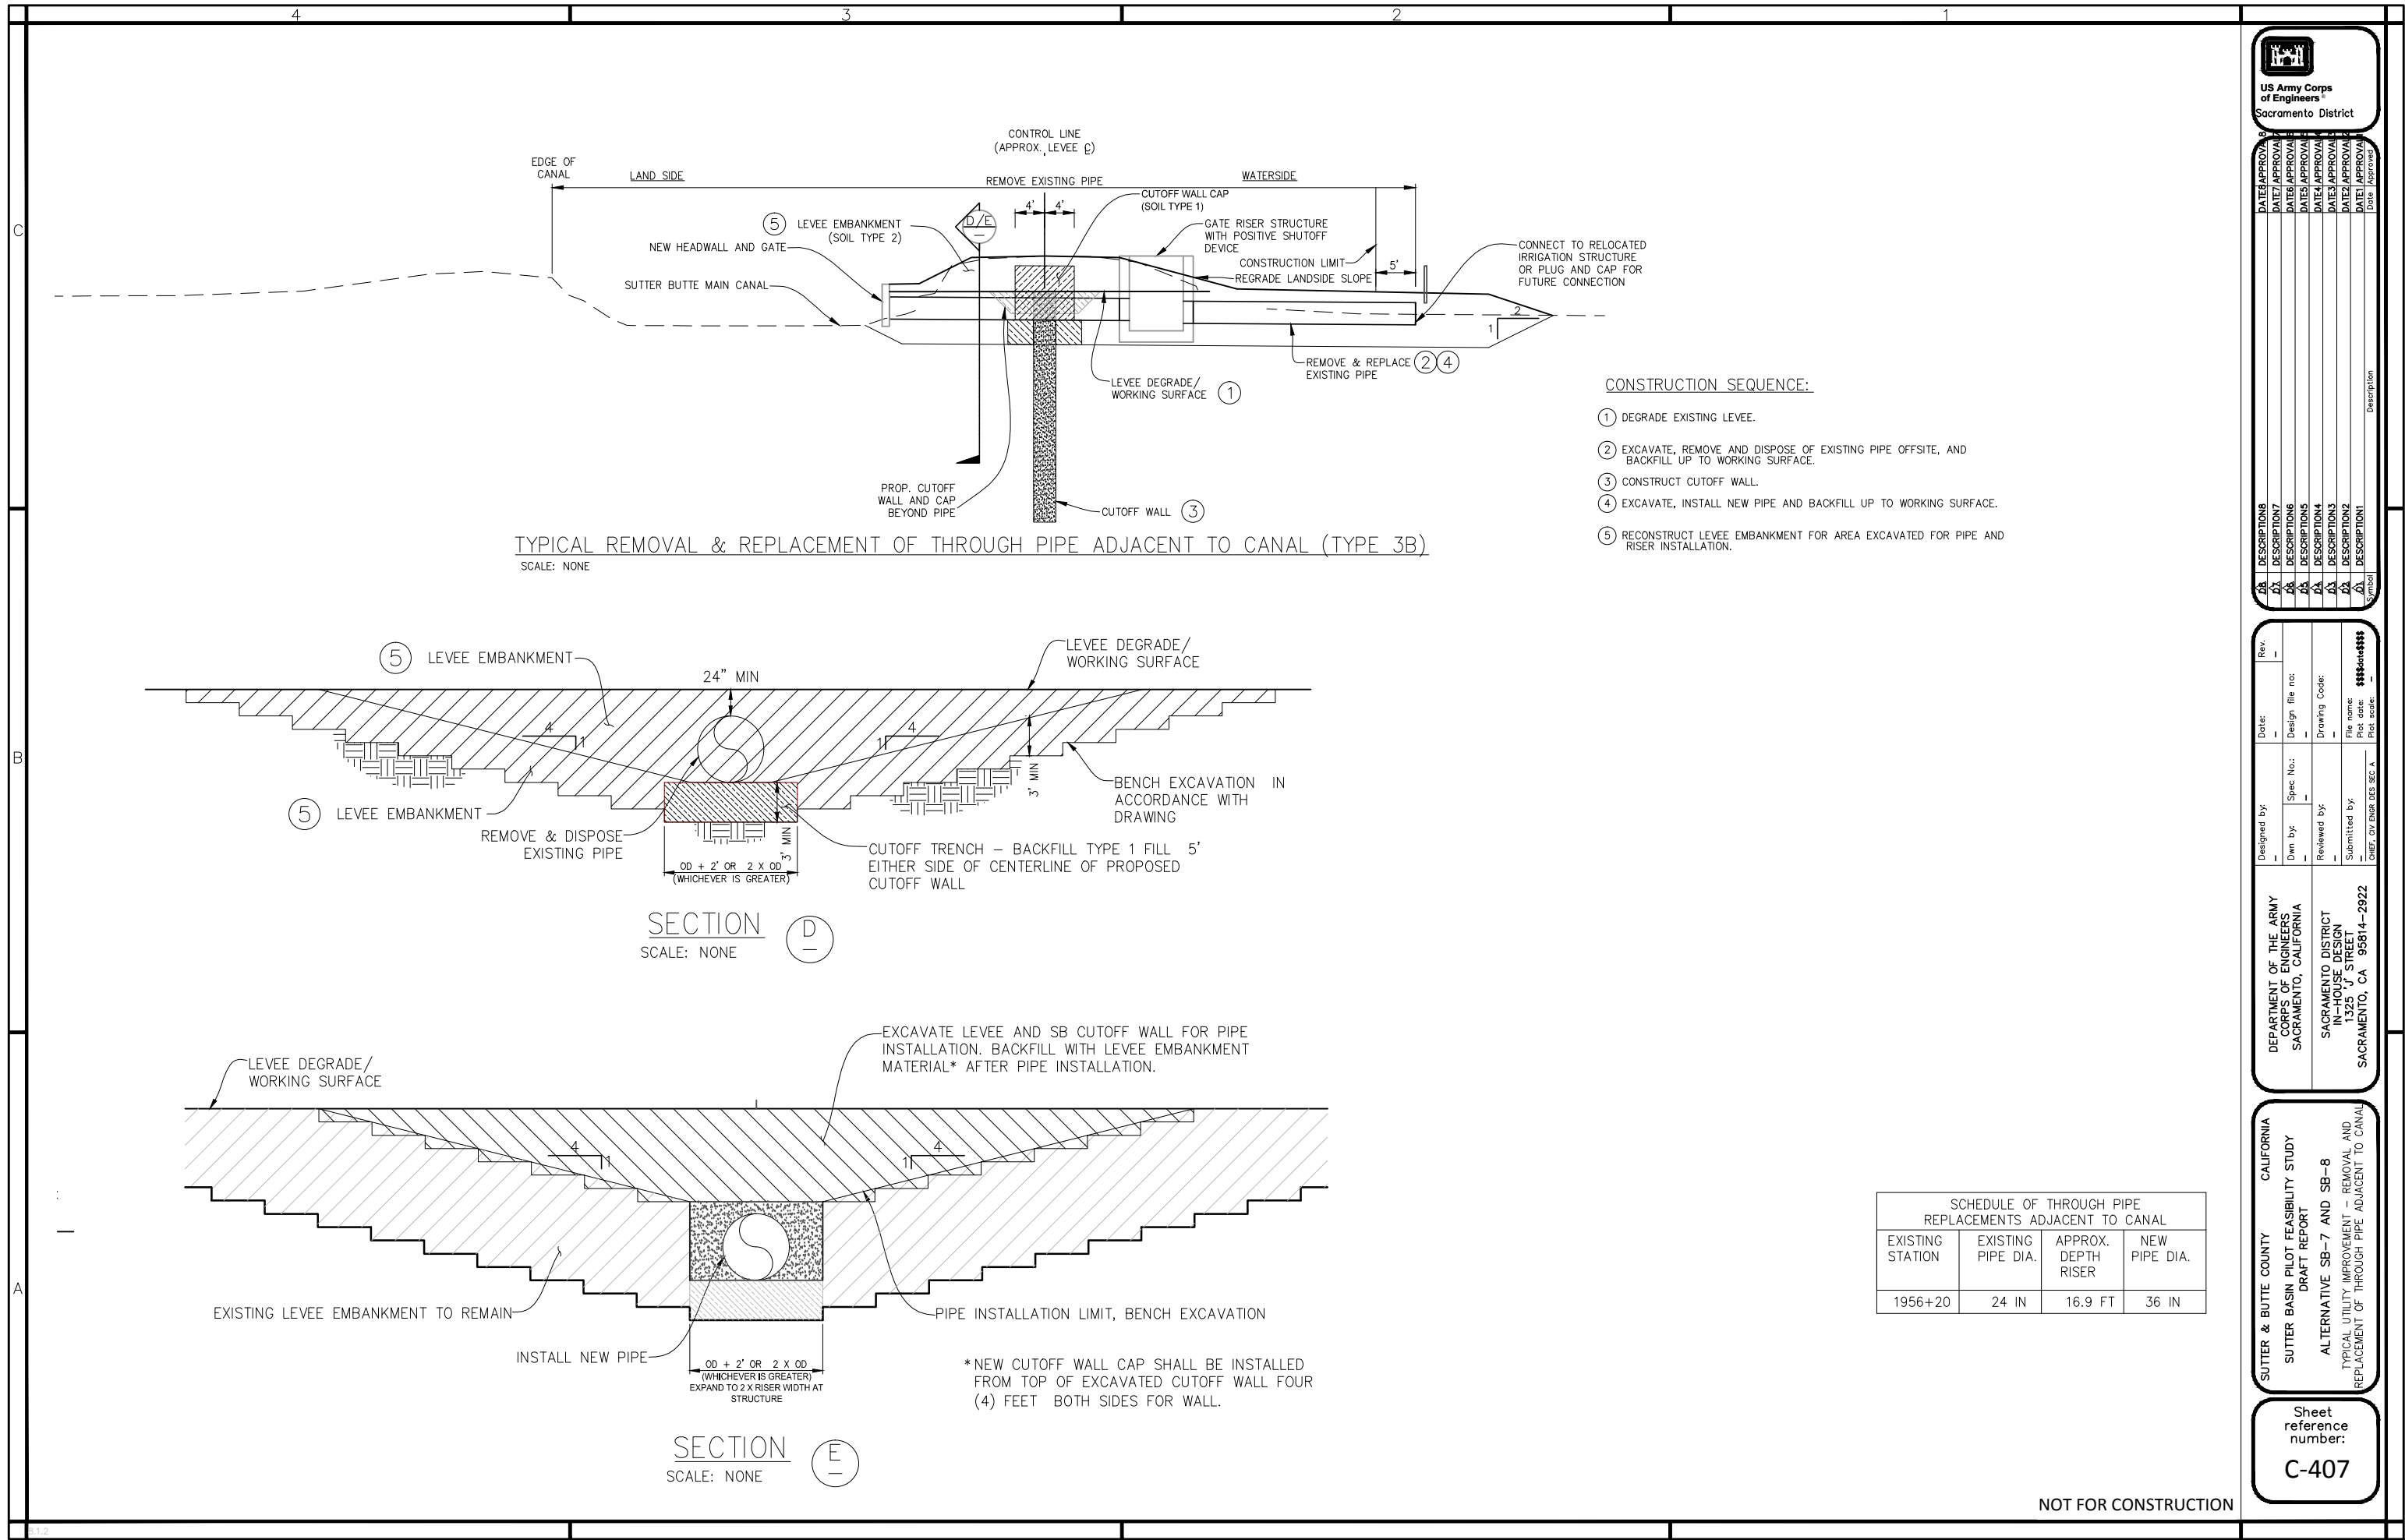SUTTER BASIN PILOT FEASIBILITY STUDY
DRAFT REPORT

ALTERNATIVE SB-7 AND SB-8
TYPICAL UTILITY IMPROVEMENT - REMOVAL AND
REPLACEMENT OF THROUGH PIPE ADJACENT TO CANAL

Sheet
reference
number:

C-407

NOT FOR CONSTRUCTION



- ① DEGRADE EXISTING LEVEE.
- ② EXCAVATE, REMOVE AND DISPOSE OF EXISTING PIPE OFFSITE, AND BACKFILL UP TO WORKING SURFACE (SEE SECTION D).
- ③ CONSTRUCT CUTOFF WALL.
- ④ EXCAVATE, INSTALL NEW PIPE AND BACKFILL UP TO WORKING SURFACE (SEE SECTION E).
- ⑤ RECONSTRUCT LEVEE EMBANKMENT FOR AREA EXCAVATED FOR PIPE AND RISER INSTALLATION.



Sheet
reference
number:
C-408

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